



ARCHITECTS + PLANNERS

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## ADDENDUM

### Addendum #01

26 August 2025

RE: Renovate 4E NMAL Office Suite  
Smithsonian Facilities Project No. 2466904  
Ayers/Saint/Gross Project No. 3000738

This Addendum forms part of the Contract Documents and modifies the original **FINAL CONSTRUCTION DOCS** dated **April 18, 2025**.

Drawings are issued with clouds and triangles. The triangles are keyed to the revision section of each drawing title block.

Changes reflected in this Addendum #01 are in general:

- Updates to millwork scope at Directors office, updates to DFH finishes, added lighting controls and removed references to new electrical panels

### **ATTACHMENTS:**

Full size drawings:

#### ARCHITECTURE

A-101FP – FLOOR PLAN – PARTIAL LEVEL 4 – NORTH  
A-406EP – INTERIOR ELEVATIONS  
A-504DT – MILLWORK DETAILS  
A-902SH – FINISH AND EQUIPMENT SCHEDULE & DETAILS  
A-903SH – DOOR SCHEDULE & DETAILS

#### ELECTRICAL

E-101LP – LIGHTING PLAN – PARTIAL LEVEL 4 – NORTH – NEW WORK  
E-501DT – ELECTRICAL DETAILS  
E-601SH – ELECTRICAL SCHEDULES  
E-602SH – PANELBOARD SCHEDULES  
E-603SH – PANELBOARD SCHEDULES  
E-902SS – ELECTRICAL SPECIFICATIONS

**CHANGES TO THE DRAWINGS**

**ARCHITECTURE**

**A-101FP – FLOOR PLAN PARTIAL LEVEL 4 - NORTH**

- Removed plan view of shelf in Director Office
- Removed elevation tag at shelf in Director Office

**A-406EP – INTERIOR ELEVATIONS**

- Removed elevation of shelf in Director Office

**A-504DT – MILLWORK DETAILS**

- Removed dimension at J5 section detail.

**A-902SH - FINISH AND EQUIPMENT SCHEDULE & DETAILS**

- Added remark to PNT-1

**A-903SH - DOOR SCHEDULE & DETAILS**

- Added door and frame finishes

**ELECTRICAL**

**E-101LP – LIGHTING PLAN – PARTIAL LEVEL 4 – NORTH – NEW WORK**

- Updated lighting controls in Storage 4014E to be timer switches

**E-501DT – ELECTRICAL DETAILS**

- Removed controlled receptacle from Detail 4.

**E-601SH – ELECTRICAL SCHEDULES**

- Added Lighting Control Intent Schedule and associate notes.

**E-602SH – PANELBOARD SCHEDULES**

- Removed note about new panels

**E-603SH – PANELBOARD SCHEDULES**

- Removed note about new panels

**E-902SS – ELECTRICAL SPECIFICATIONS**

- Removed specification language on bonding jumpers.

**End Addendum 01**

## GENERAL NOTES - NEW WORK

- DO NOT SCALE DRAWINGS. VERIFY DIMENSIONS, BOUNDARIES, AND CONSTRUCTION AND IMMEDIATELY REPORT ANY DISCREPANCIES TO THE SI COTR BEFORE PROCEEDING WITH THE WORK.
- SI COTR IS NOT RESPONSIBLE FOR CONSTRUCTION THAT IS STARTED PRIOR TO PERMIT BEING ISSUED.
- WOOD BLOCKING, FRAMING AND PLYWOOD SHEATHING SHALL BE FIRE RETARDANT TREATED (F.R.T.) UNLESS OTHERWISE NOTED, IN ACCORDANCE WITH THE LATEST AWPA STANDARDS FOR PLYWOOD AND LUMBER, APPLICABLE BUILDING CODES, AND UNLESS OTHERWISE NOTED.
- DIMENSIONS, NOTES, FINISHES AND FIXTURES SHOWN ON TYPICAL FLOOR PLANS, SECTIONS OR DETAILS SHALL APPLY TO SIMILAR, SYMMETRICAL OR OPPOSITE HAND PLANS, SECTIONS OR DETAILS.
- TYPICAL OR "TYP" SHALL MEAN THAT THE CONDITION IS REPRESENTATIVE FOR SIMILAR CONDITIONS THROUGHOUT, UNLESS OTHERWISE NOTED. DETAILS MAY BE KEYED AND NOTED "TYP" ONLY ONE TIME, WHEN THEY FIRST OCCUR.
- IMMEDIATELY NOTIFY THE SI COTR IN WRITING OF ANY DISCREPANCIES IN THE CONTRACT DOCUMENTS INCLUDED IN THE PROJECT MANUAL, LARGE SCALE DRAWINGS, SMALL SCALE DRAWINGS AND DETAILS. THE CONTRACTOR SHALL NOT PROCEED WITH AFFECTED WORK UNTIL SI COTR PROVIDES CLARIFICATION.
- PROVIDE APPROVED THROUGH-PENETRATION FIRE STOPPING SYSTEM AT RATED WALL OR FLOOR PENETRATIONS. MAINTAIN PROPER FIRE AND SOUND RATINGS WHEN PENETRATING THROUGH WALLS, FLOORS OR CEILINGS.
- APPLY, INSTALL, CONNECT, CLEAN AND/OR CONDITION MANUFACTURED ARTICLES, MATERIALS AND/OR EQUIPMENT PER MANUFACTURER'S INSTRUCTIONS. IN CASE OF CONFLICT BETWEEN MANUFACTURER'S INSTRUCTIONS AND THE CONTRACT DOCUMENTS, THE CONTRACTOR SHALL OBTAIN WRITTEN CLARIFICATION FROM THE SI COTR BEFORE PROCEEDING.


- DOOR HARDWARE SHALL COMPLY WITH ADA (AMERICANS WITH DISABILITIES ACT) REQUIREMENTS, INCLUDING, BUT NOT LIMITED TO:
  - MAXIMUM 1/2" THRESHOLD WITH 1:2 SLOPE
  - PUSH/PULL HANDLES OR LEVERS
  - DOOR CLOSERS MEET ADA FORCE AND SWEEP PERIOD REQUIREMENTS
- COORDINATE ALL DIMENSIONS CONCERNING DOORS AND THEIR OPENINGS WITH PRODUCT MANUFACTURER'S PRIOR TO FABRICATION AND CONSTRUCTION.
- PAINT FERROUS OR GALVANIZED METAL EXPOSED TO VIEW IN FINISHED CONSTRUCTION, OTHER THAN COMPLETELY FACTORY PREFINISHED ITEMS SPECIFIED.
- LOCATE THERMOSTATS ADJACENT TO SWITCH PLATES WHERE POSSIBLE. VERIFY LOCATION WITH THE SI COTR PRIOR TO INSTALLATION TO AVOID CONFLICTS WITH BUILT-INS OR SYSTEMS FURNITURE OR DESIGN ELEMENTS.
- ALIGN OUTLETS, WALL SWITCHES, TEL-DATA JACKS, ETC., INDICATED TO BE MOUNTED AT NEAR EQUIVALENT ELEVATIONS.
- JUNCTION BOXES FOR SECURITY/TELECOMMUNICATIONS/ELECTRICAL, ETC., DEVICES LOCATED WITHIN ACOUSTICALLY RATED PARTITIONS BUT SERVING SEPARATE ROOMS SHALL BE LOCATED IN SEPARATE STUD BAYS. INSTANCES WHERE THE DOCUMENTS LOCATE DEVICES BACK TO BACK, NOTIFY SI COTR IN WRITING FOR DIRECTION.
- ALL DOORS SHALL BE LOCATED 6" OFF OF THE ADJACENT WALL, UNLESS OTHERWISE NOTED.
- DIMENSIONS ARE FROM FACE OF WALL TO FACE OF WALL, (I.E. FACE OF GYPSUM BOARD OR MASONRY) OR FROM FACE OF EXISTING CONDITION OR FROM COLUMN CENTERLINE, UNLESS OTHERWISE NOTED. DIMENSIONS NOTED AS "CLEAR" SHALL BE FROM FINISH FACE TO FINISH FACE, (I.E. FACE OF CERAMIC TILE TO FACE OF CERAMIC TILE). VERIFY ALL EXISTING DIMENSIONS IN THE FIELD.
- ALL COLUMNS SHALL BE ENCLOSED IN GWB. WHERE EXPOSED COLUMN FACES EXIST, CONTRACTOR SHALL INSTALL PARTITION TYPE A2 TO ENCLOSE COLUMN AND ALIGN WITH NEW PARTITIONS.

- PROVIDE FIRE-TREATED WOOD BLOCKING OR MINIMUM 0.0312-INCH THICK STEEL FLAT STRAP AND BACKING PLATE AT, BUT NOT LIMITED TO, THE FOLLOWING LOCATIONS: TOILET ACCESSORIES, CASEWORK, MILLWORK, DOOR WALL BUMPERS, AND ALL OTHER WALL MOUNTED EQUIPMENT OR DEVICES. REFER TO PLAN FOR ADDITIONAL LOCATIONS.
- FLOOR PATCH AND FLOOR LEVELING: REPAIR EXISTING TOPPING SLAB AND CONCRETE FLOOR AT DEMOLITION OF WALLS AND AT ALL OTHER LOCATIONS AS REQUIRED.
- PATCH TO MATCH EXISTING:
  - PROVIDE ALL OPENINGS REQUIRED FOR ALL TRADES AND PATCH TO MATCH EXISTING, AT EXISTING CONSTRUCTION ALTERED OR DISTURBED BY THE INSTALLATION, RELOCATION, OR REMOVAL OF HEATING, VENTILATING, AIR CONDITIONING, PLUMBING AND/OR ELECTRICAL EQUIPMENT AND DEVICES.
  - PATCH TO MATCH EXISTING (PTME), ALL AREAS ADJACENT TO, OR DISTURBED BY, NEW CONSTRUCTION OR EXISTING CONSTRUCTION TO BE REMOVED. PATCH TO MATCH INCLUDES FINISH MATERIAL (PAINT OR CERAMIC TILE... ETC.) TO MATCH EXISTING.
  - PATCH ALL DEFECTS IN, AND FINISH TO MATCH EXISTING, ALL AREAS WHICH ARE TO RECEIVE NEW MATERIALS, FINISHES AND ITEMS CALLED FOR IN THE CONTRACT DOCUMENTS. PREPARE ALL EXISTING SURFACES TO RECEIVE NEW FINISHES AS REQUIRED.

Key Value	KEYNOTE TEXT
PL-01	RE-INSTALL FIRE HOSE CONNECTION IN NEW LOCATION.
PL-02	PATCH AND REPAIR EXISTING PARTITIONS TO REMAIN WHERE DEMOLITION OCCURRED.
PL-03	PROVIDE BID OPTION TO PROVIDE AND INSTALL NEW GLASS SIDELITE, TYP.
PL-04	PROVIDE BID OPTION TO PROVIDE AND INSTALL GLAZING IN CHANNELS AS SHOWN.
PL-05	IF NEW POWER RECEPTACLE AND ASSOCIATED WIRING CANNOT BE CONCEALED IN EXISTING COLUMN FURRING, INSTALL NEW A3 PARTITION TYPE AT FACE OF COLUMN TO ALLOW FOR CONCEALMENT.


## FLOOR PLAN LEGEND

- AREA NOT IN SCOPE
- EXISTING WALL TO REMAIN
- NEW WALL
- NEW DOOR
- EXISTING DOOR
- BRACKET MOUNTED FIRE EXTINGUISHER

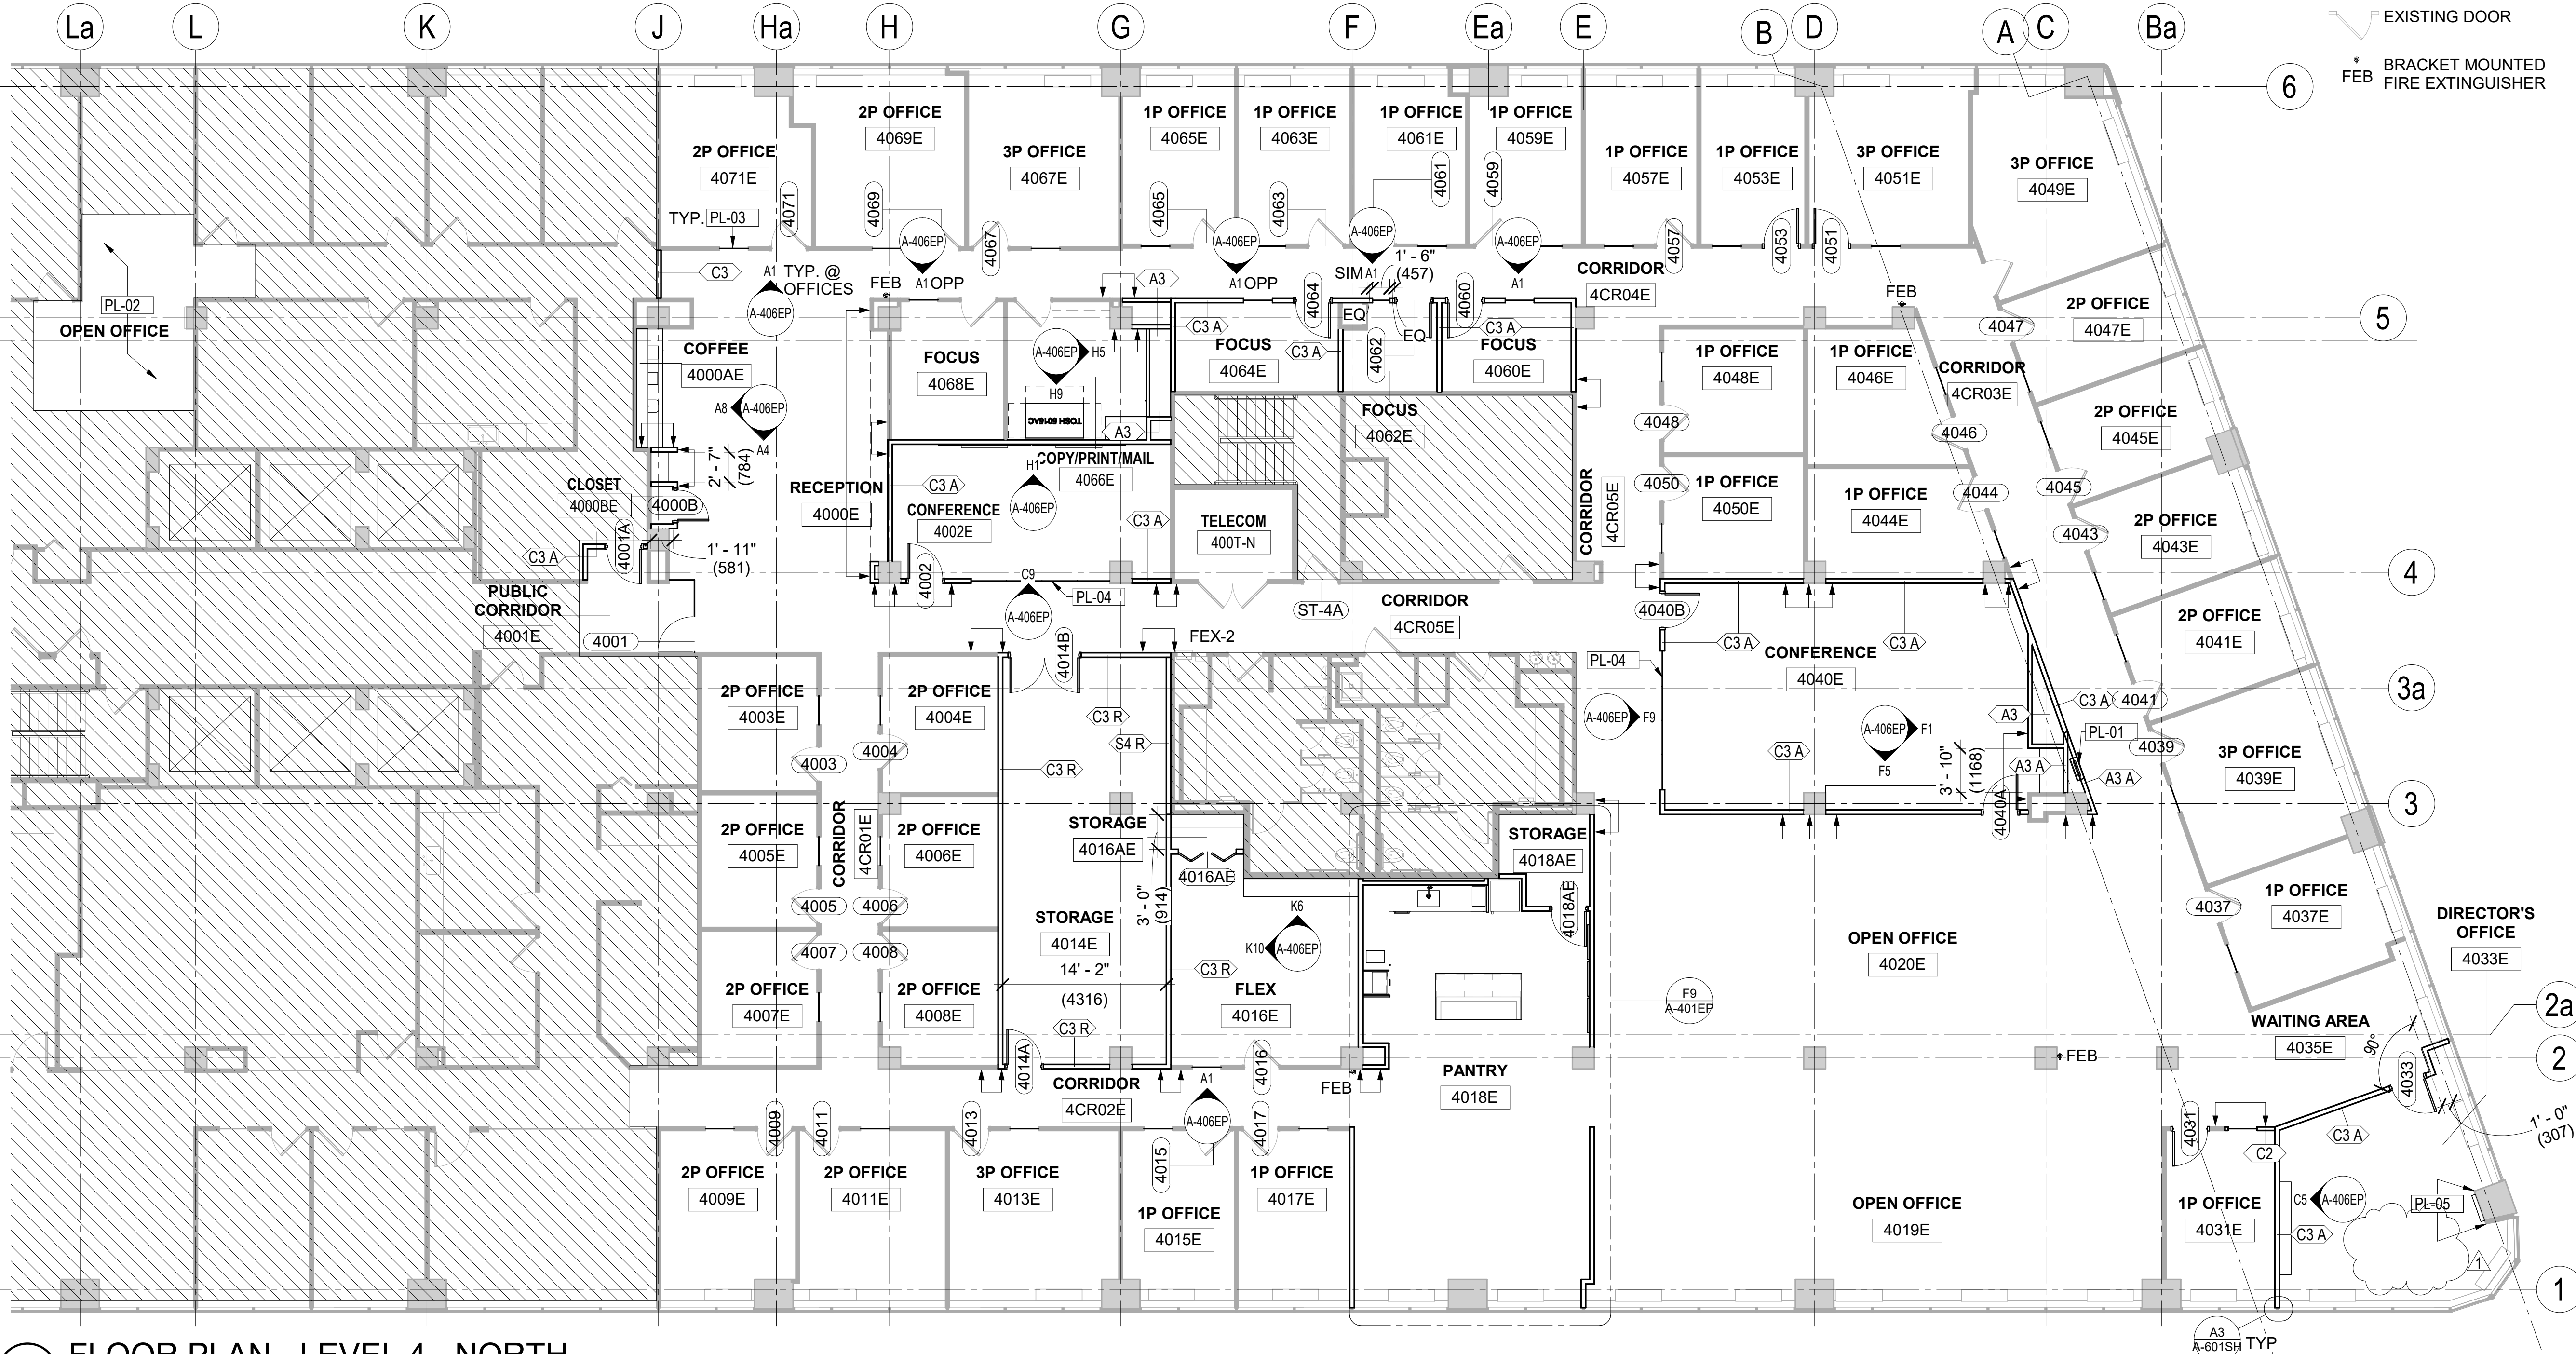

**FLOOR PLAN - LEVEL 4 - NORTH**  
SCALE = 1/8" = 1'-0"

CG

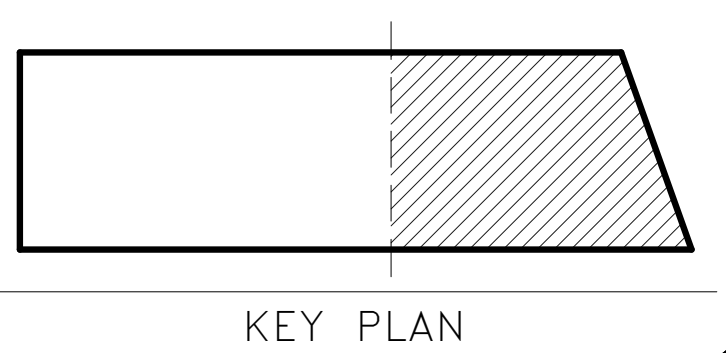
Renovate 4E NMAL  
Office SuiteFOR  
CONSTRUCTION

0 8' 16' 32'

1/16"=1'-0"

## GRAPHIC SCALE(S)

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04/18/25	FINAL CONSTRUCTION DOC'S
REVISION # DATE	REVISION DESCRIPTION
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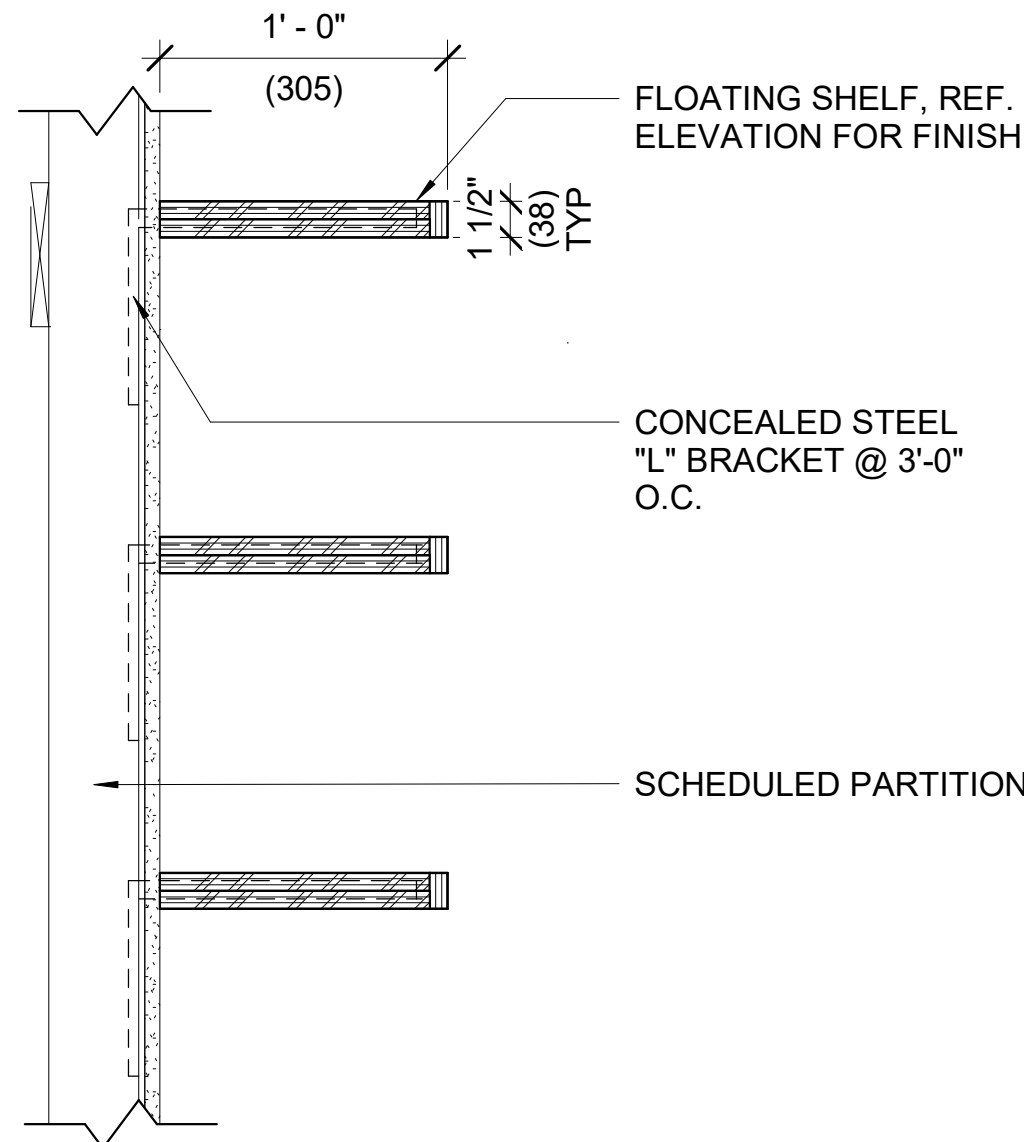
Smithsonian  
Institution600 Maryland Avenue S.W. Suite 5001  
Washington, DC 20024-2520

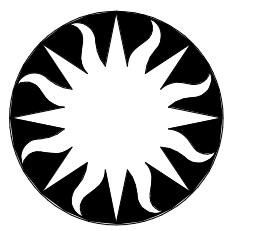BUILDING NAME	CAPITAL GALLERY ADMIN HQ, EAST
ADDRESS	600 MARYLAND AVE, SW
PROJECT TITLE	RENOVATE 4E NMAL OFFICE SUITE
SI PROJECT NUMBER	2466904
A/E PROJECT NUMBER	ASG 3000738.00
DRAWING TITLE	FLOOR PLAN - PARTIAL LEVEL - NORTH
WORKING STAFF	JR KR SS DESIGNED BY DRAWN BY CHECKED BY
SHEET NO.	A - 101FP
6 of 75	DISCIPLINE TYPE SEQUENCE DRAWING TYPE




SHEET NO.	A - 406	EP
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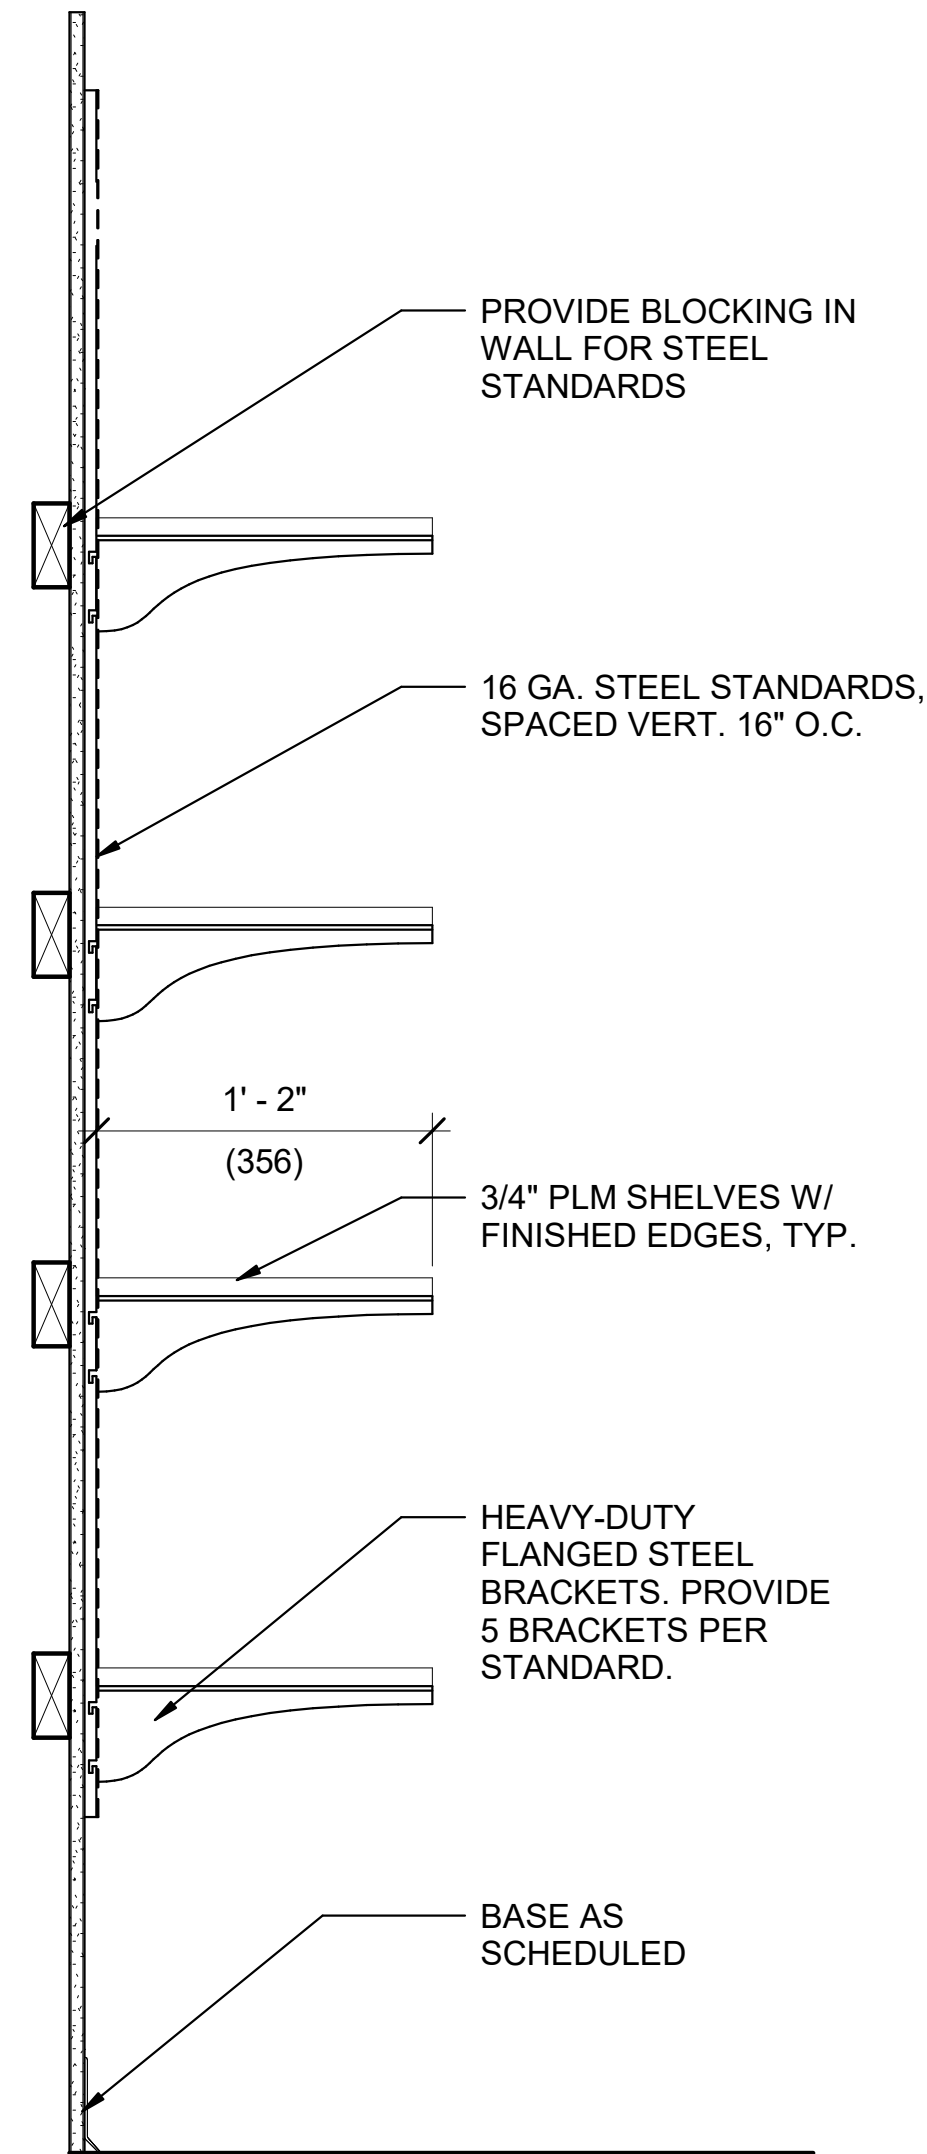
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A-504DT BY LIG 04/18/25 FINAL CONSTRUCTION DOCS




**J1**  
A-504DT  
**FLOATING SHELVES (DIR OFFICE)**  
SCALE = 1 1/2" = 1'-0"

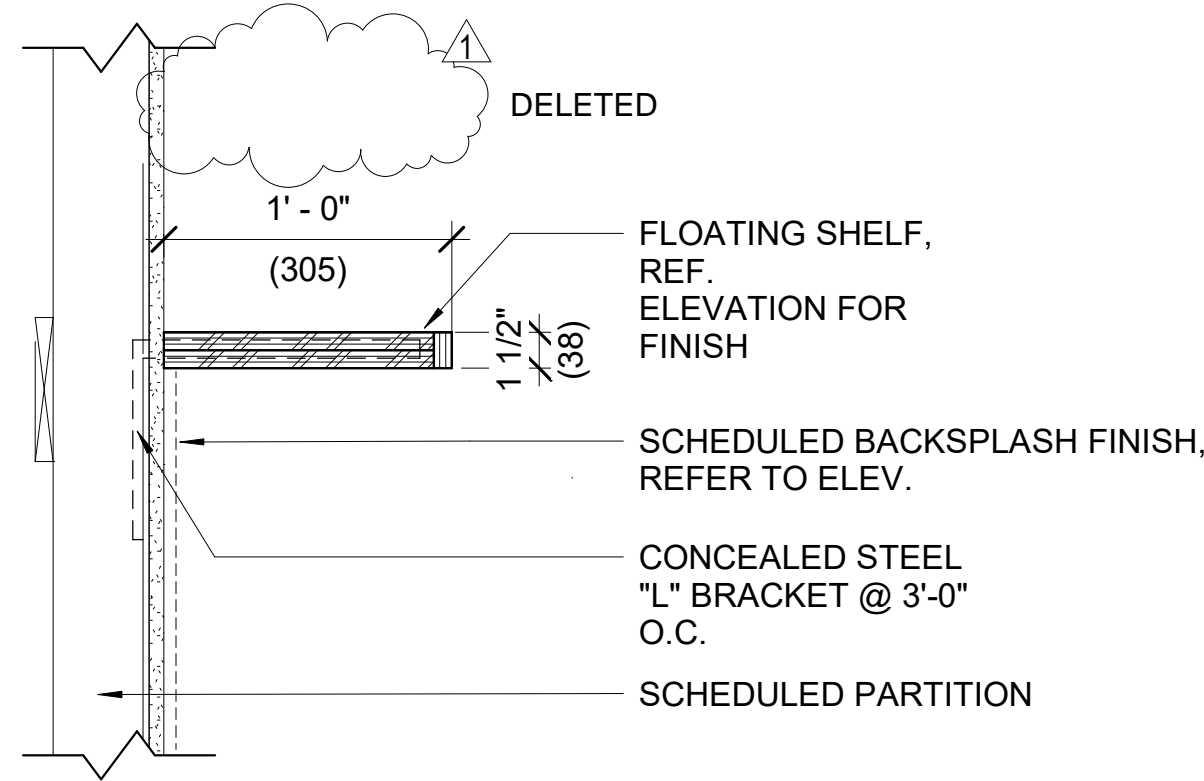


**J5**  
A-504DT  
**SECTION DETAIL - FLOATING SHELF**  
SCALE = 1 1/2" = 1'-0"




**F9**  
A-504DT  
**FULL WALL SHELVING - PLM**  
SCALE = 1 1/2" = 1'-0"

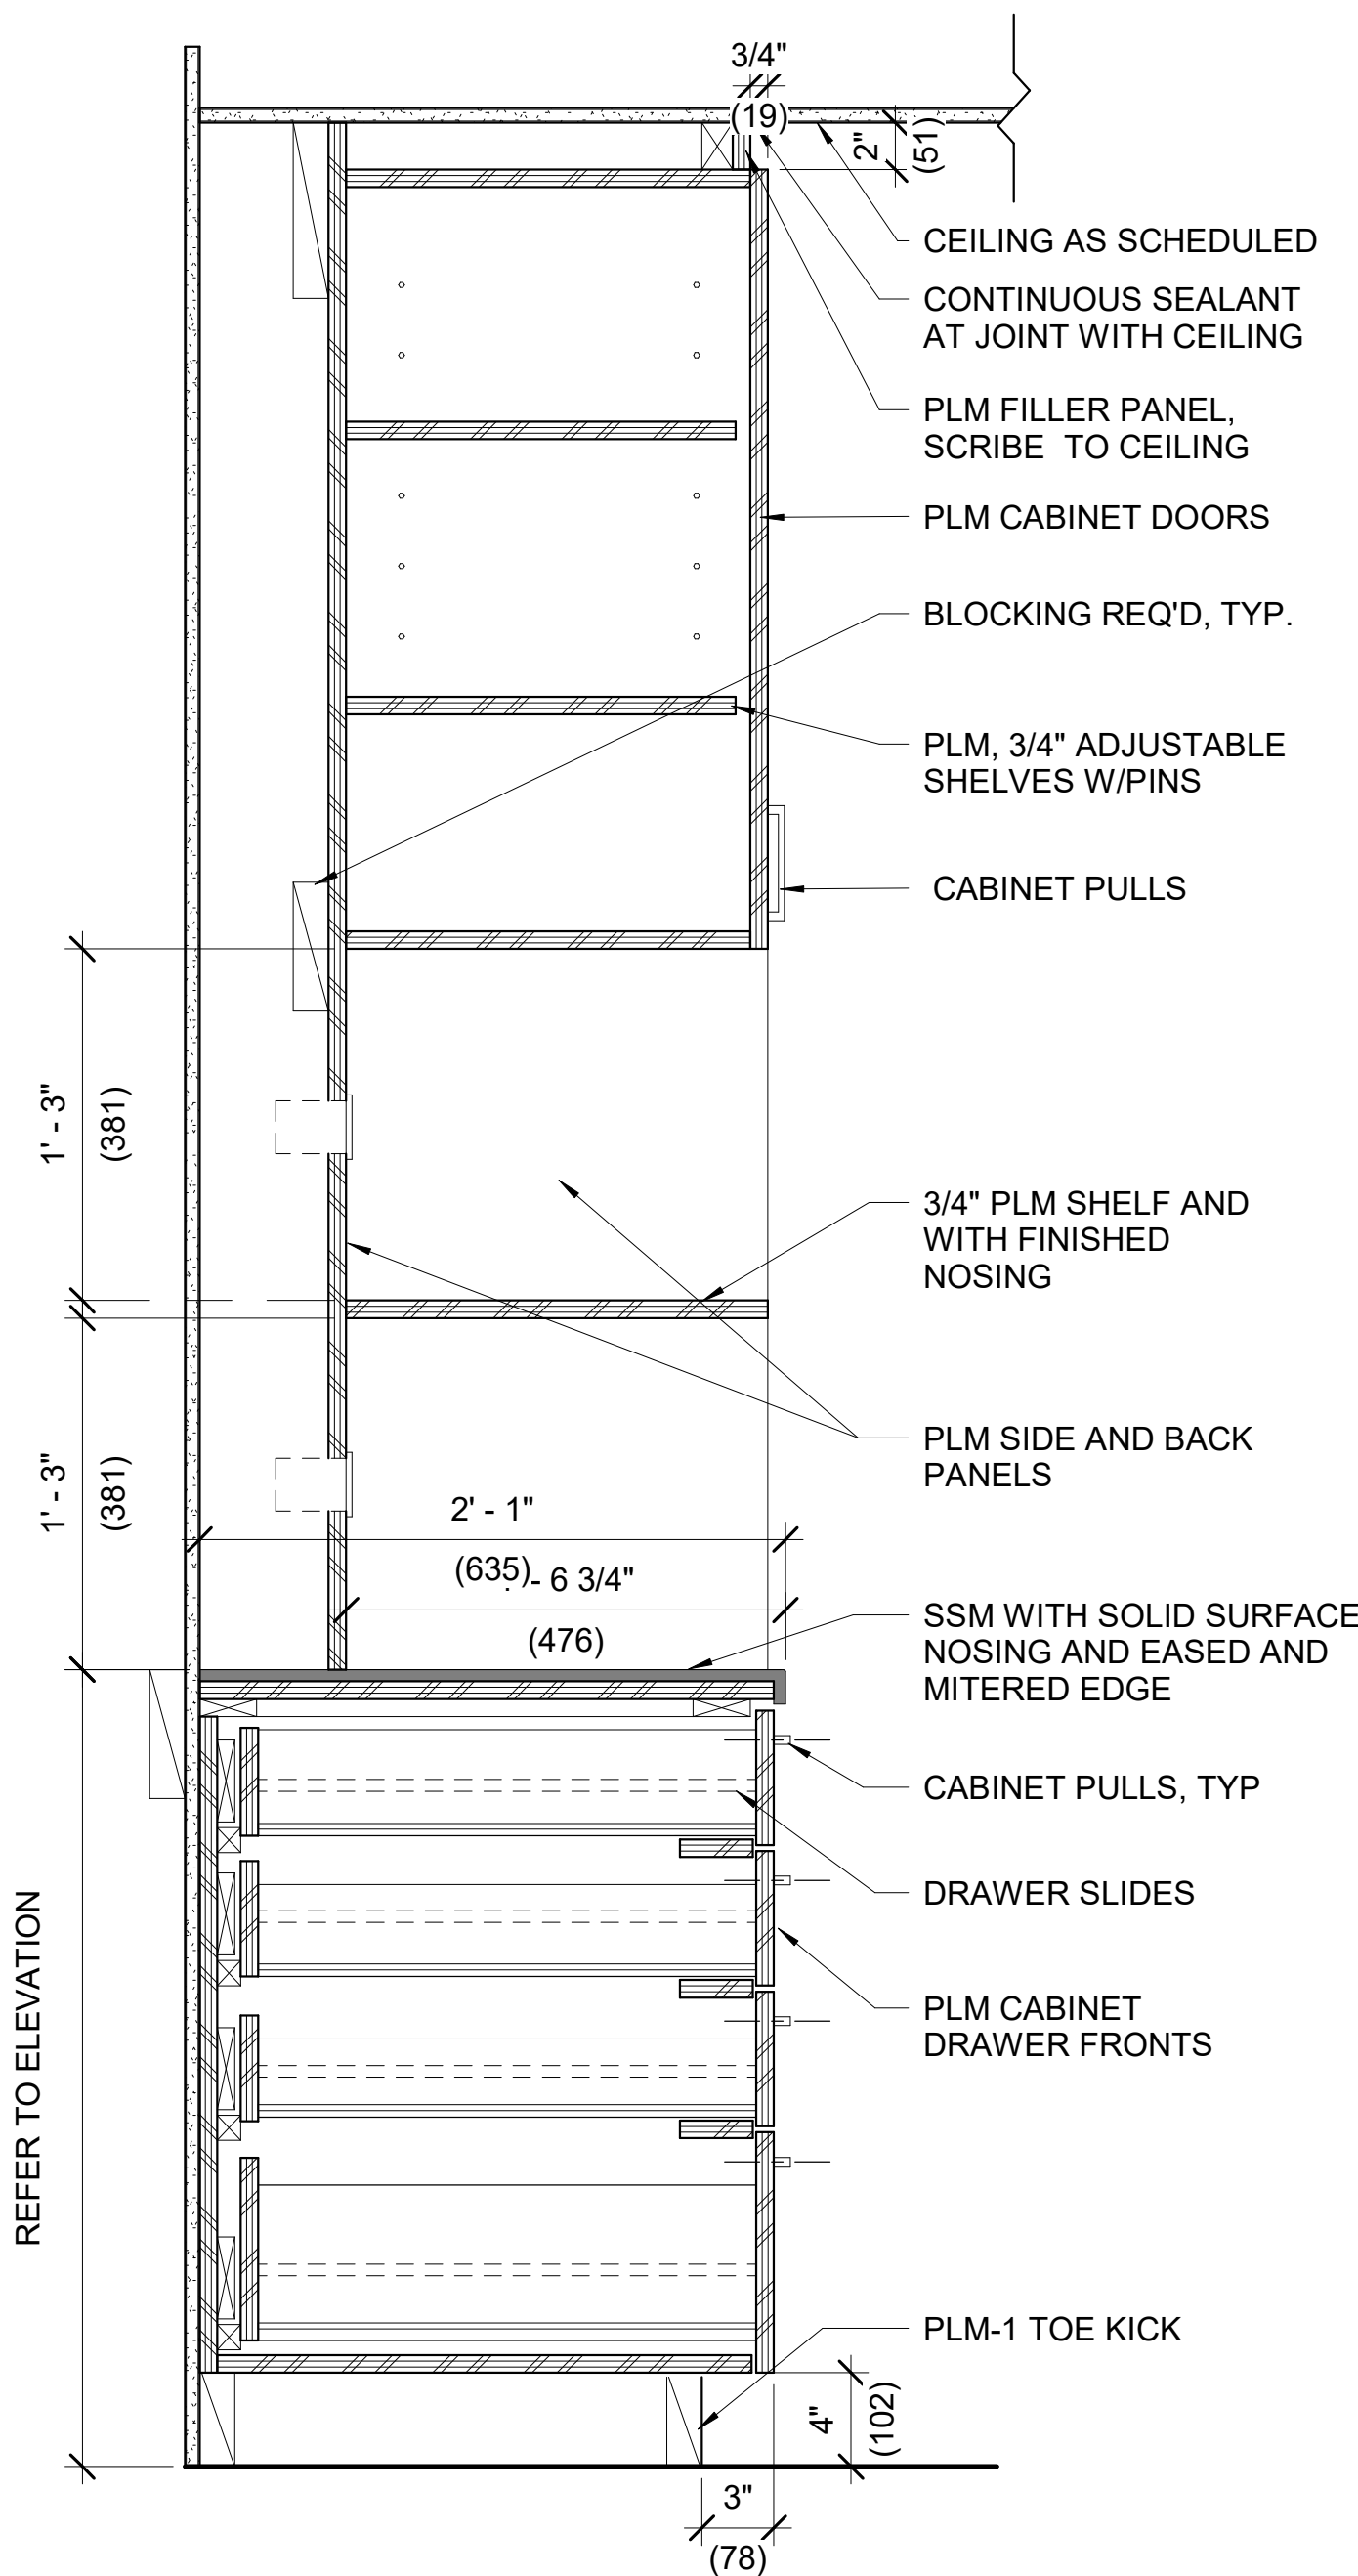


**A1**  
A-504DT  
**FULL HEIGHT TOWER**  
SCALE = 1 1/2" = 1'-0"

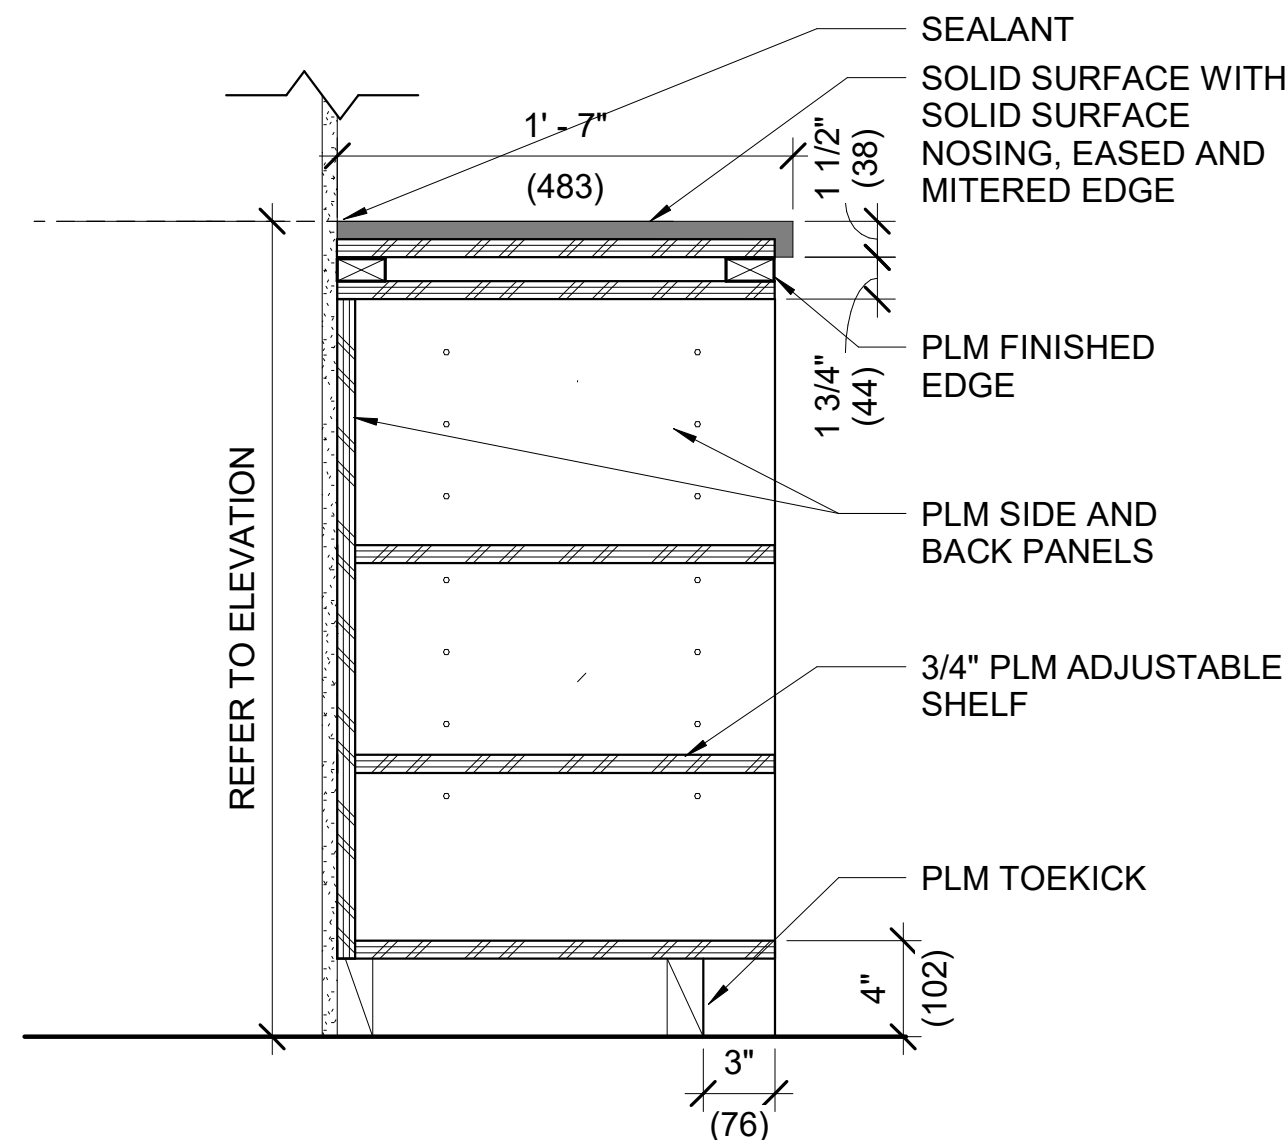

**E5**  
A-504DT  
**BASE - OPEN SHELVING**  
SCALE = 1 1/2" = 1'-0"

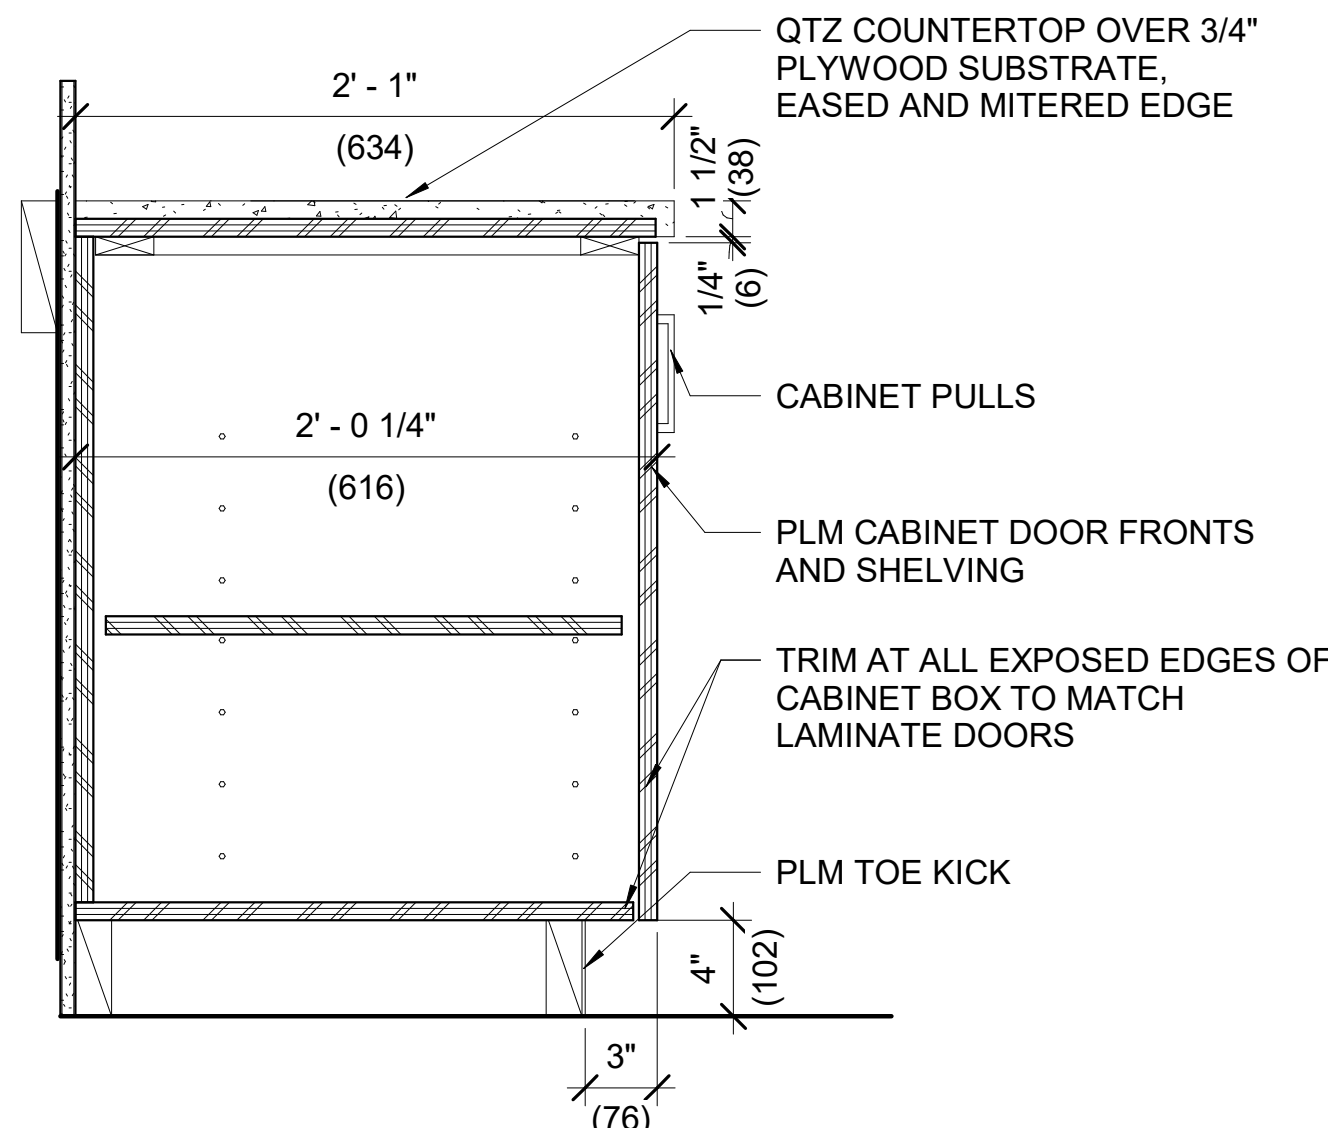

**A5**  
A-504DT  
**BASE - CABINET ONLY - QTZ**  
SCALE = 1 1/2" = 1'-0"

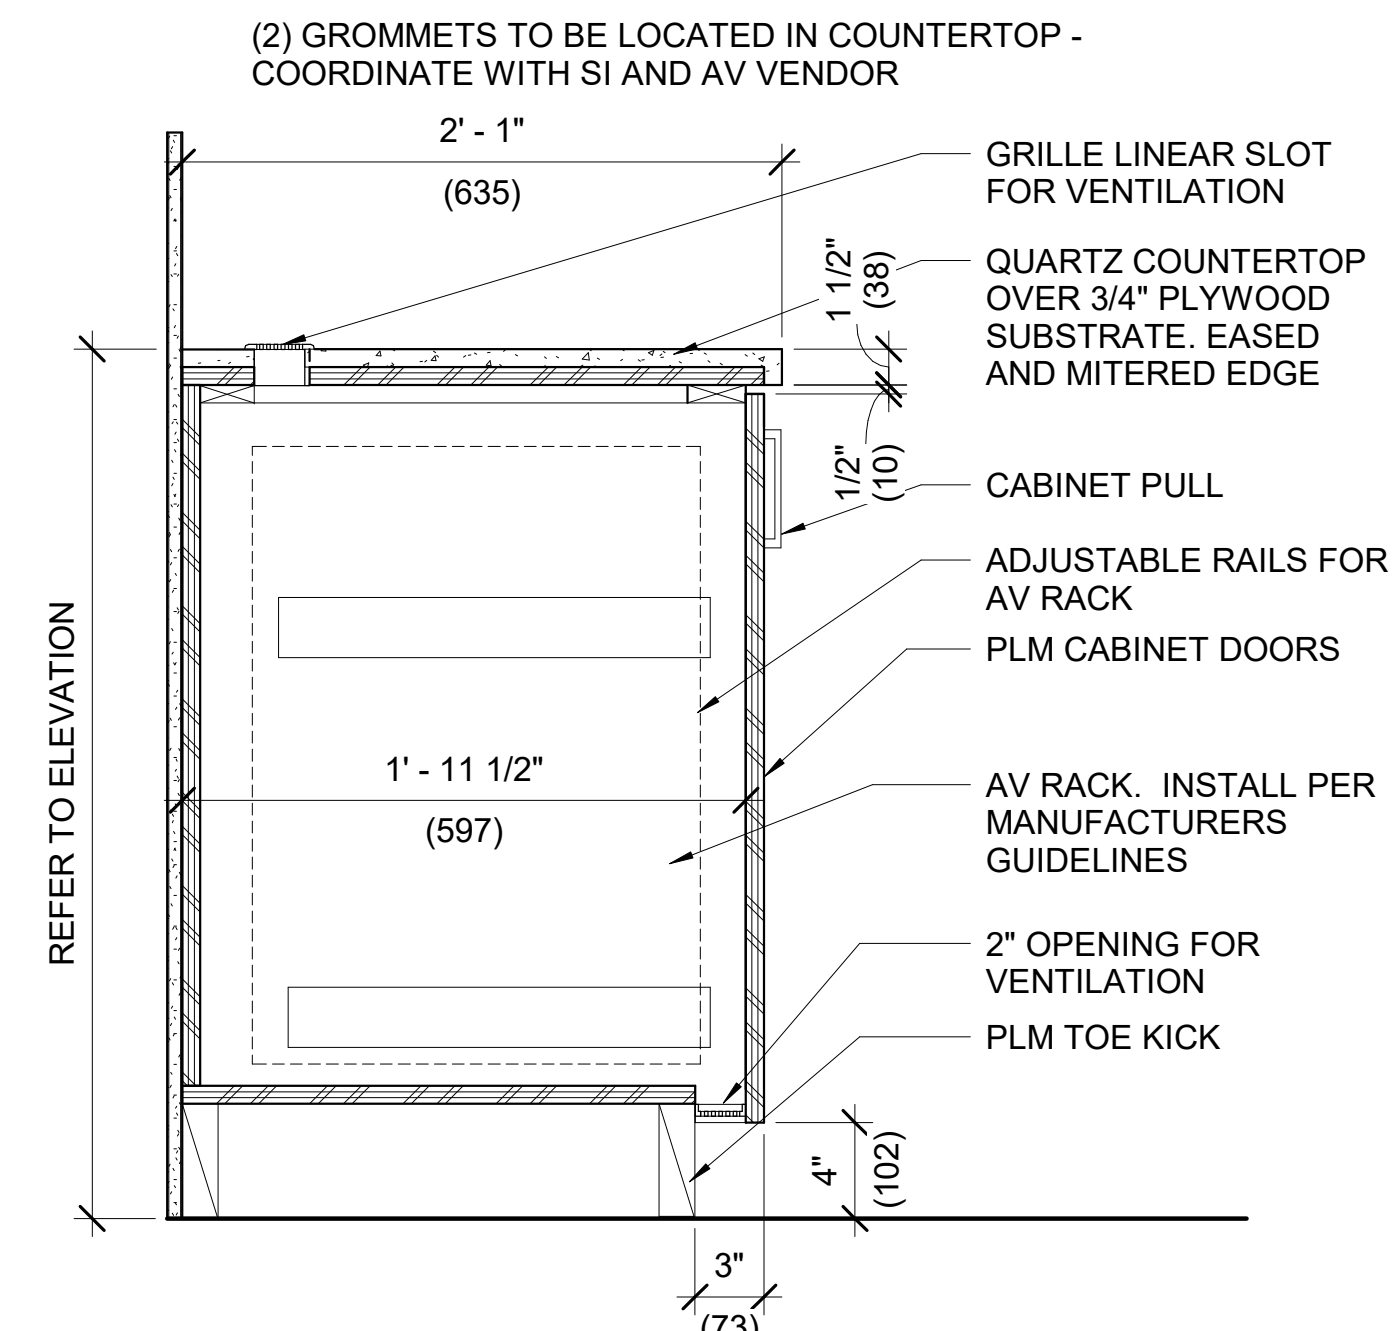


**A9**  
A-504DT  
**BASE - CABINET VENTED FOR AV - QTZ**  
SCALE = 1 1/2" = 1'-0"

CG

Renovate 4E NMAL  
Office Suite

FOR  
CONSTRUCTION

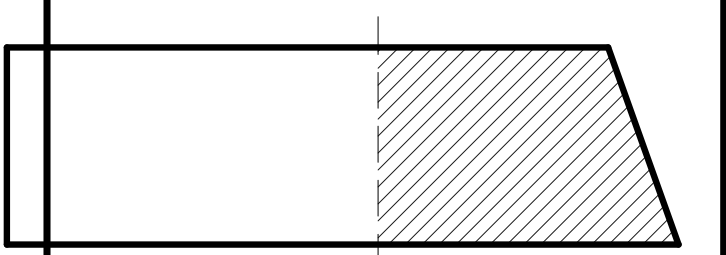


KEY PLAN

0 1/2' 1' 1 1/2'  
1 1/2"=1'-0"

GRAPHIC SCALE(S)

DATE	SUBMISSION	
04/18/25	FINAL CONSTRUCTION DOCS	
REVISION	DATE	REVISION DESCRIPTION
1	08/26/25	ADDENDUM #1

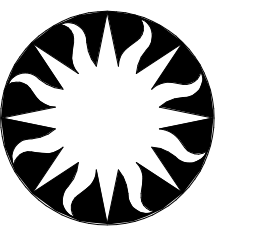

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Institution


600 Maryland Avenue S.W. Suite 5001  
Washington, DC 20024-2520

BUILDING NAME	CAPITAL GALLERY ADMIN HQ, EAST
ADDRESS	600 MARYLAND AVE, SW
PROJECT TITLE	RENOVATE 4E NMAL OFFICE SUITE
SI PROJECT NUMBER	2466904
A/E PROJECT NUMBER	ASG 3000738.00
DRAWING TITLE	MILLWORK DETAILS
WORKING STAFF	JR KR SS
SHEET NO.	13 OF 75
DISCIPLINE	A-504DT
TYPE	
SEQUENCE	
DRAWING TYPE	




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A-902SH BY LKG 04/18/25 FINAL CONSTRUCTION DOCS

M  
L  
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A

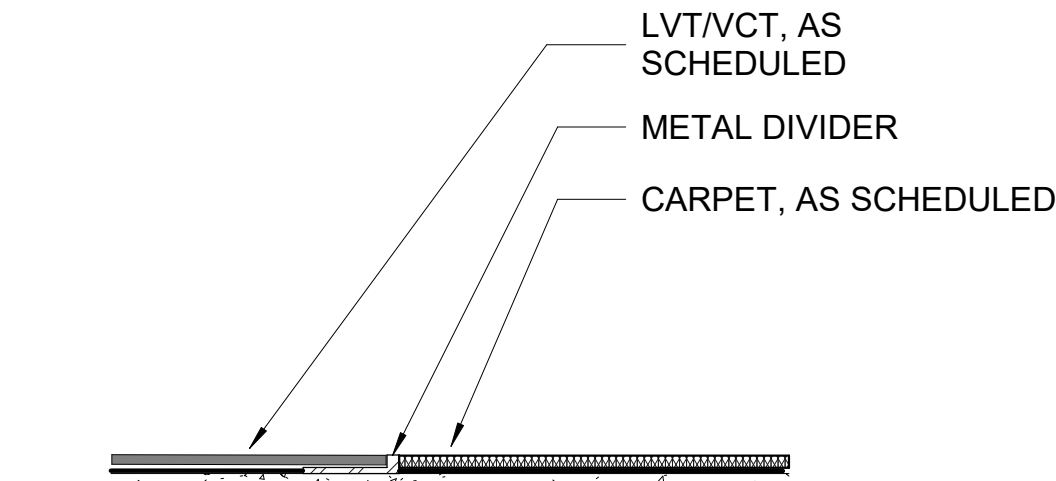


**G1**  
A-902SH  
SCALE = 6" = 1'-0"

**TRANSITION - LVT/VCT TO CARPET**

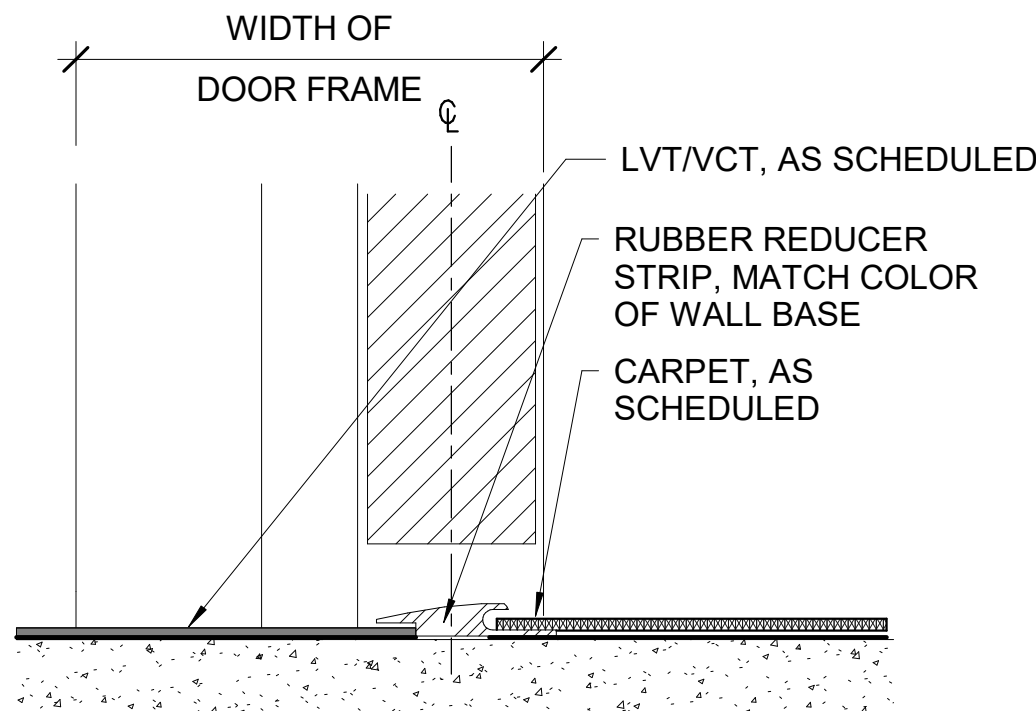

**D1**  
A-902SH  
SCALE = 6" = 1'-0"

**THRESHOLD - CARPET TO LVT/VCT**

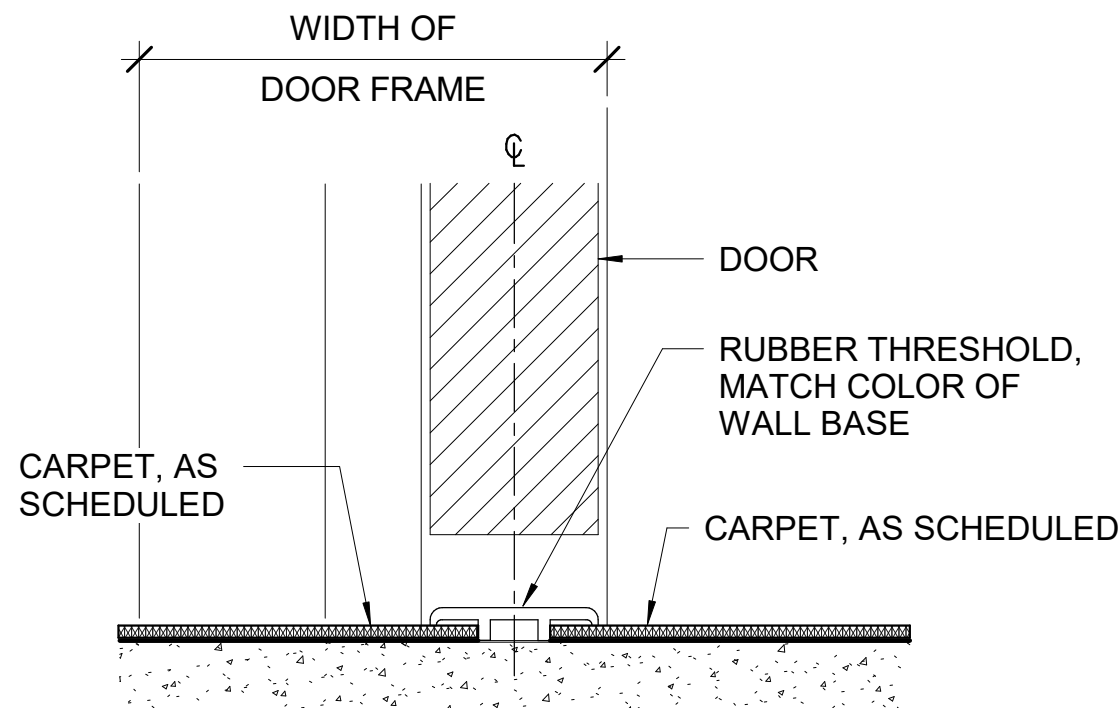


**A1**  
A-902SH  
SCALE = 6" = 1'-0"

**THRESHOLD - CARPET TO CARPET**

INTERIOR FINISHES ABBREVIATION KEY						
MARK	MANUFACTURER	MATERIAL	SERIES / STYLE	COLOR	LOCATION	REMARKS
1 FLOOR COVERING SCHEDULE						
CPT-1	PATCRAFT	CARPET TILE	24"X24" SCAFFOLD IO519	00530 CUSTOM - TRYK # F947700	THROUGHOUT, UNO	ASHLAR INSTALLATION; CUSTOM YARN E - 5597D LOOP
CPT-2	PATCRAFT	CARPET TILE	24"X24" TRANSVERSE IO520	00530 CUSTOM - TRYK # F949322	CONFERENCE, FLEX, FOCUS	ASHLAR INSTALLATION; CUSTOM YARN E - 5597D LOOP
LVT-1	SHAW	LUXURY VINYL TILE	6"x36" UNVEIL	CHAR	COPY, PANTRY	ASHLAR INSTALLATION, 45 DEGREE INSTALL UNO; REFER TO FINISH PLANS
VCT-1	ARMSTRONG	VINYL COMPOSITE TILE	12"x12" PREMIUM EXCELOX STONETEX	52125 GRANITE GREY	STORAGE 430	STRAIGHT STACK
2 WALL BASE SCHEDULE						
RBB-1	TARKETT	RUBBER BASE	4" COVE	63 BURNT UMBER	THROUGHOUT, UNO	
WDB-1		MDF	4" FLAT STOCK MDF - 1/4" THICK	PTD TO MATCH WALL	PUBLIC CORRIDOR	
3 WALL COVERING SCHEDULE						
CTW-1	DALTILE	CERAMIC WALL TILE	3"X6" COLOR WHEEL	1090 ARCTIC WHITE	PANTRY BACKSPLASH, COFFEE BACKSPLASH	MATTE FINISH; GROUT MAPEI #19
CTW-2	DALTILE	CERAMIC WALL TILE	3"X6" COLOR WHEEL	0782 SUEDE GREY	PANTRY BACKSPLASH	MATTE FINISH; GROUT MAPEI #19
CTW-3	DALTILE	CERAMIC WALL TILE	3"X6" COLOR WHEEL	1049 OCEAN BLUE	PANTRY BACKSPLASH	GLOSSY FINISH; GROUT MAPEI#19
CTW-4	DALTILE	CERAMIC WALL TILE	3"X6" COLOR WHEEL	1174 SEA BREEZE	PANTRY BACKSPLASH	GLOSSY FINISH; GROUT MAPEI #19
CTW-5	DALTILE	CERAMIC WALL TILE	3"X6" COLOR WHEEL	0115 EMERALD	PANTRY BACKSPLASH	GLOSSY FINISH; GROUT MAPEI #19
CTW-6	DALTILE	CERAMIC WALL TILE	3"X6" COLOR WHEEL	1098 KEY LIME	PANTRY BACKSPLASH	GLOSSY FINISH; GROUT MAPEI #19
CTW-7	DALTILE	CERAMIC WALL TILE	3"X6" COLOR WHEEL	1012 MUSTARD	PANTRY BACKSPLASH	GLOSSY FINISH; GROUT MAPEI #19
TWC-1	MAHARAM	TACKABLE WALL COVERING	TEK WALL HALE	002 ELEVATE	FLEX	FWP-1; REFER TO ELEVATION
TWC-2	MAHARAM	TACKABLE WALL COVERING	TEK WALL TINT	002 SHIMMER	PANTRY	FWP-1; REFER TO ELEVATION
4 CEILING SCHEDULE						
APC-1	ARMSTRONG	ACOUSTIC PANEL CEILING	CALLA HIGH CAC TEGULAR 8807 2'X2'	WHITE	THROUGHOUT, UNO	GRID: SILHOUETTE XL 1/8" REVEAL 9/16"
APC-2	ARMSTRONG	ACOUSTIC PANEL CEILING	CALLA SHAPES FOR DESIGNFLEX 100106, PATTERN SH16	WHITE	PANTRY	GRID: SUPRAFINE XM 9/16" WITH 2" AXIOM TRANSITIONS AND DRYWALL BOTTOM TRIM
APC-3	MATCH EXISTING	ACOUSTIC PANEL CEILING	MATCH EXISTING		PUBLIC CORRIDOR	MATCH EXISTING GRID
GBC-1	ARMSTRONG	GYPSON BOARD	DRYWALL FLAT CEILING SUSPENSION SYSTEM	PAINTED PNT-1, UNO	SEE RCP	SEE FINISH PLAN FOR ACCENT PAINT COLORS, FLAT FINISH
5 MILLWORK SCHEDULE						
PLM-1	WILSONART	PLASTIC LAMINATE		LINEN D427-60	MILLWORK VERTICAL SURFACES THROUGHOUT	
PLM-2	WILSONART	PLASTIC LAMINATE		RAW CHESTNUT 7975K-12	SHELF	
QTZ-1	CORIAN	QUARTZ	2CM	SNOW WHITE	NEW COUNTERTOPS @ CONFERENCE	POLISHED FINISH
SSM-1	CORIAN	SOLID SURFACE	1/2"	CARBON CONCRETE	NEW COUNTERTOPS THROUGHOUT, UNO	
6 PAINT SCHEDULE						
PNT-1	SHERWIN WILLIAMS	PAINT		SW7005 PURE WHITE	THROUGHOUT, UNO	EGGSHELL FINISH @ WALLS; FLAT @ CEILINGS; SEMI-GLOSS @ DOORS/FRAMES
PNT-2	SHERWIN WILLIAMS	PAINT		SW6725 PICKLE		EGGSHELL FINISH @ WALLS
PNT-3	SHERWIN WILLIAMS	PAINT		SW6671 CURRY		EGGSHELL FINISH @ WALLS
PNT-4	SHERWIN WILLIAMS	PAINT		SW6488 GRAND CANAL		EGGSHELL FINISH @ WALLS; FLAT @ CEILINGS
PNT-5	SHERWIN WILLIAMS	PAINT		SW 6485 RAINDROP		EGGSHELL FINISH
PNT-6	SHERWIN WILLIAMS	PAINT		TBD	DIRECTOR'S OFFICE	EGGSHELL FINISH
8 FABRIC WRAPPED PANEL						
FWP-1	ACCUTRACK SYSTEMS	ACCUSNAP	1/2" ACOUSTICAL & TACKABLE PANEL .55 NRC RATING	REFER TO ELEVATION	REFER TO ELEVATIONS	SQUARE EDGE

EQUIPMENT SCHEDULE							
#	TYPE	LOCATION	MANUFACTURER	MODEL #	DESCRIPTION	COMMENT	COLOR
EQ-01	WATER DISPENSER	PANTRY, COFFEE BAR	NATURAL CHOICE	TS 400	COUNTERTOP WATER DISPENSER WITH INTEGRAL FILTER	PURCHASED BY OWNER; INSTALLED BY GC	TITANIUM/CHARCOAL TRIM
EQ-02	UNDERCOUNTER FREEZER	PANTRY	PERLICK	HA24FB-4-5	24" SLIDE IN FREEZER DRAWERS, ADA COMPLIANT	PURCHASED BY GC; INSTALLED BY GC	STAINLESS STEEL
EQ-03	REFRIGERATOR	PANTRY	WHIRLPOOL	WSR57R18D	RIGHT DOOR SWING REFRIGERATOR	PURCHASED BY GC; INSTALLED BY GC	STAINLESS STEEL
EQ-04	COFFEE MACHINE	COFFEE BAR	KEURIG	K-3500	COFFEE MACHINE, REQUIRES A DIRECT WATER LINE	PURCHASED BY OWNER; INSTALLED BY GC	BLACK
EQ-05	MICROWAVE	PANTRY	GE	PEB9159SJSS	MIRCROWAVE OVEN	PURCHASED BY OWNER; INSTALLED BY OWNER	STAINLESS STEEL
EQ-06	UNDERCOUNTER REFRIGERATOR	PANTRY, COFFEE BAR	PERLICK	HA2RB-4-1L	24" SLIDE IN REFRIGERATOR, ADA COMPLIANT	PURCHASED BY GC; INSTALLED BY GC	STAINLESS STEEL
EQ-08	UNDERCOUNTER ICE MAKER	PANTRY	PERLICK	H50IMS-ADL	15" SLIDE IN ICE MAKER, ADA COMPLIANT	PURCHASED BY GC; INSTALLED BY GC	STAINLESS STEEL
EQ-09	DISHWASHER	PANTRY	GE	PDT145SSLSS	18" SLIDE IN DISHWASHER, ADA COMPLIANT	PURCHASED BY GC; INSTALLED BY GC	STAINLESS STEEL
EQ-11	ESPRESSO MACHINE	PANTRY	ZULAY KITCHEN	MAGIA SUPER AUTOMATIC	ESPRESSO MACHINE, DOES NOT REQUIRE A DIRECT WATER LINE	PURCHASED BY OWNER; INSTALLED BY OWNER	BLACK, MIDNIGHT SILVER TRIM

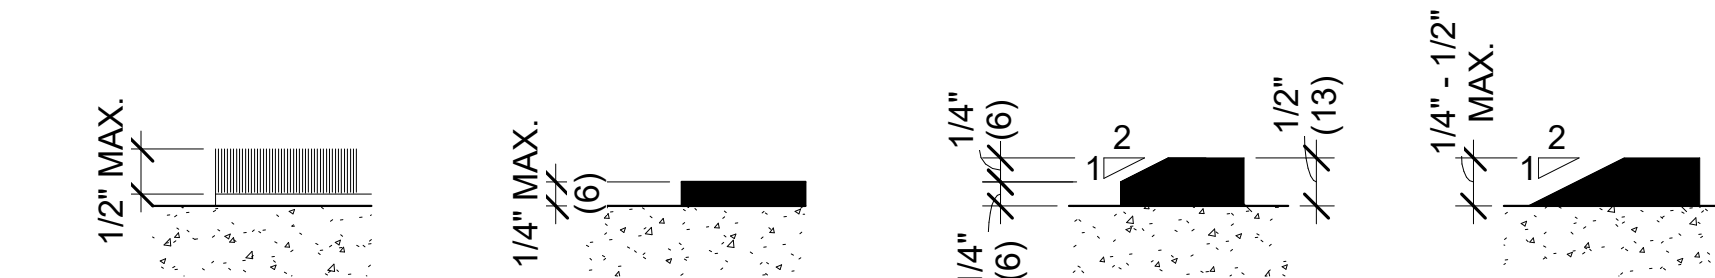

NOTES:  
1. VERTICAL LEVEL CHANGES OF 1/4" MAXIMUM ARE PERMITTED WITHOUT EDGE TREATMENT.

**A5**  
A-902SH  
SCALE = 6" = 1'-0"

**FLOOR TRANSITION NOTES**


CG

Renovate 4E NMAL  
Office Suite


FOR  
CONSTRUCTION



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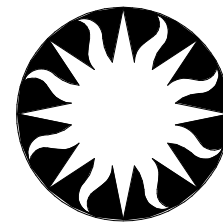


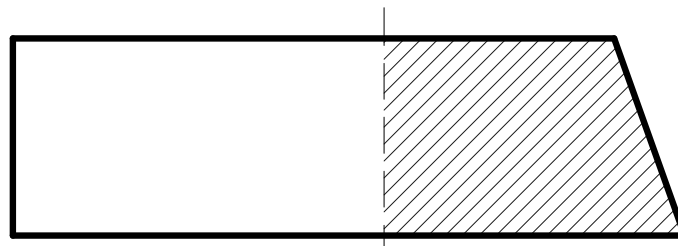KEY PLAN

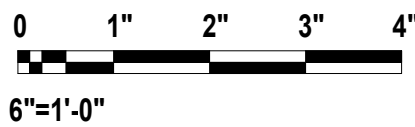

GRAPHIC SCALE(S)


DATE	SUBMISSION	
04/18/25	FINAL CONSTRUCTION DOCS	
REVISION #	DATE	REVISION DESCRIPTION
1	08/26/25	ADDENDUM #1



Smithsonian  
Institution

600 Maryland Avenue S.W. Suite 5001  
Washington, DC 20024-2520

BUILDING NAME	CAPITAL GALLERY ADMIN HQ, EAST		
ADDRESS	600 MARYLAND AVE, SW		
PROJECT TITLE	RENOVATE 4E NMAL OFFICE SUITE		
SI PROJECT NUMBER	2466904		
A/E PROJECT NUMBER	ASG 3000738.00		
DRAWING TITLE	FINISH & EQUIPMENT SCHEDULE & DETAILS		
WORKING STAFF	JR	KR	SS
DESIGNED BY		DRAWN BY	
CHECKED BY			
SHEET NO.	A - 902SH		
17 of 75	DISCIPLINE	TYPE	SEQUENCE
			DRAWING TYPE

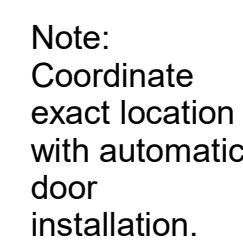

# A1 A-903SH TYPICAL CORRIDOR ITEMS MOUNTING HEIGHTS SCALE = 3/8" = 1'-0"


Figure 1 shows details of the test specimens. It includes four diagrams labeled A, B, C, and D. Diagram A is a simple rectangle. Diagram B is a rectangle with a vertical dashed line in the center and two 'EQ' labels above it. Diagram C is a rectangle with dimensions: 3'-0" (914) width, 6" (152) top and bottom flanges, 6" (152) side flanges, and 10" (254) height. Diagram D is a rectangle with dimensions: 8'-2" (2489) height, 2" (51) top and bottom flanges, and 2" (51) side flanges. A note indicates F1 = 3'-0" and F2 = 6'-0".

**DOOR TYPES**

**FRAME TYPES**

1. ALL NEW HOLLOW METAL (HM) FRAMES FOR NEW DOORS INSTALLED IN NEW PARTITIONS TO BE WELDED FRAMES.
2. ALL FIRE RATED DOORS AND FRAMES SHALL BE LABELED PER THE INDICATED FIRE RATING, REF AL001AL.
3. ALL DOORS CALLED OUT WITH FINISH LABEL "PNT" SHALL RECEIVE PNT-1.

SHEET NO.	A	-	9	0	3	S	H
18 of 75							

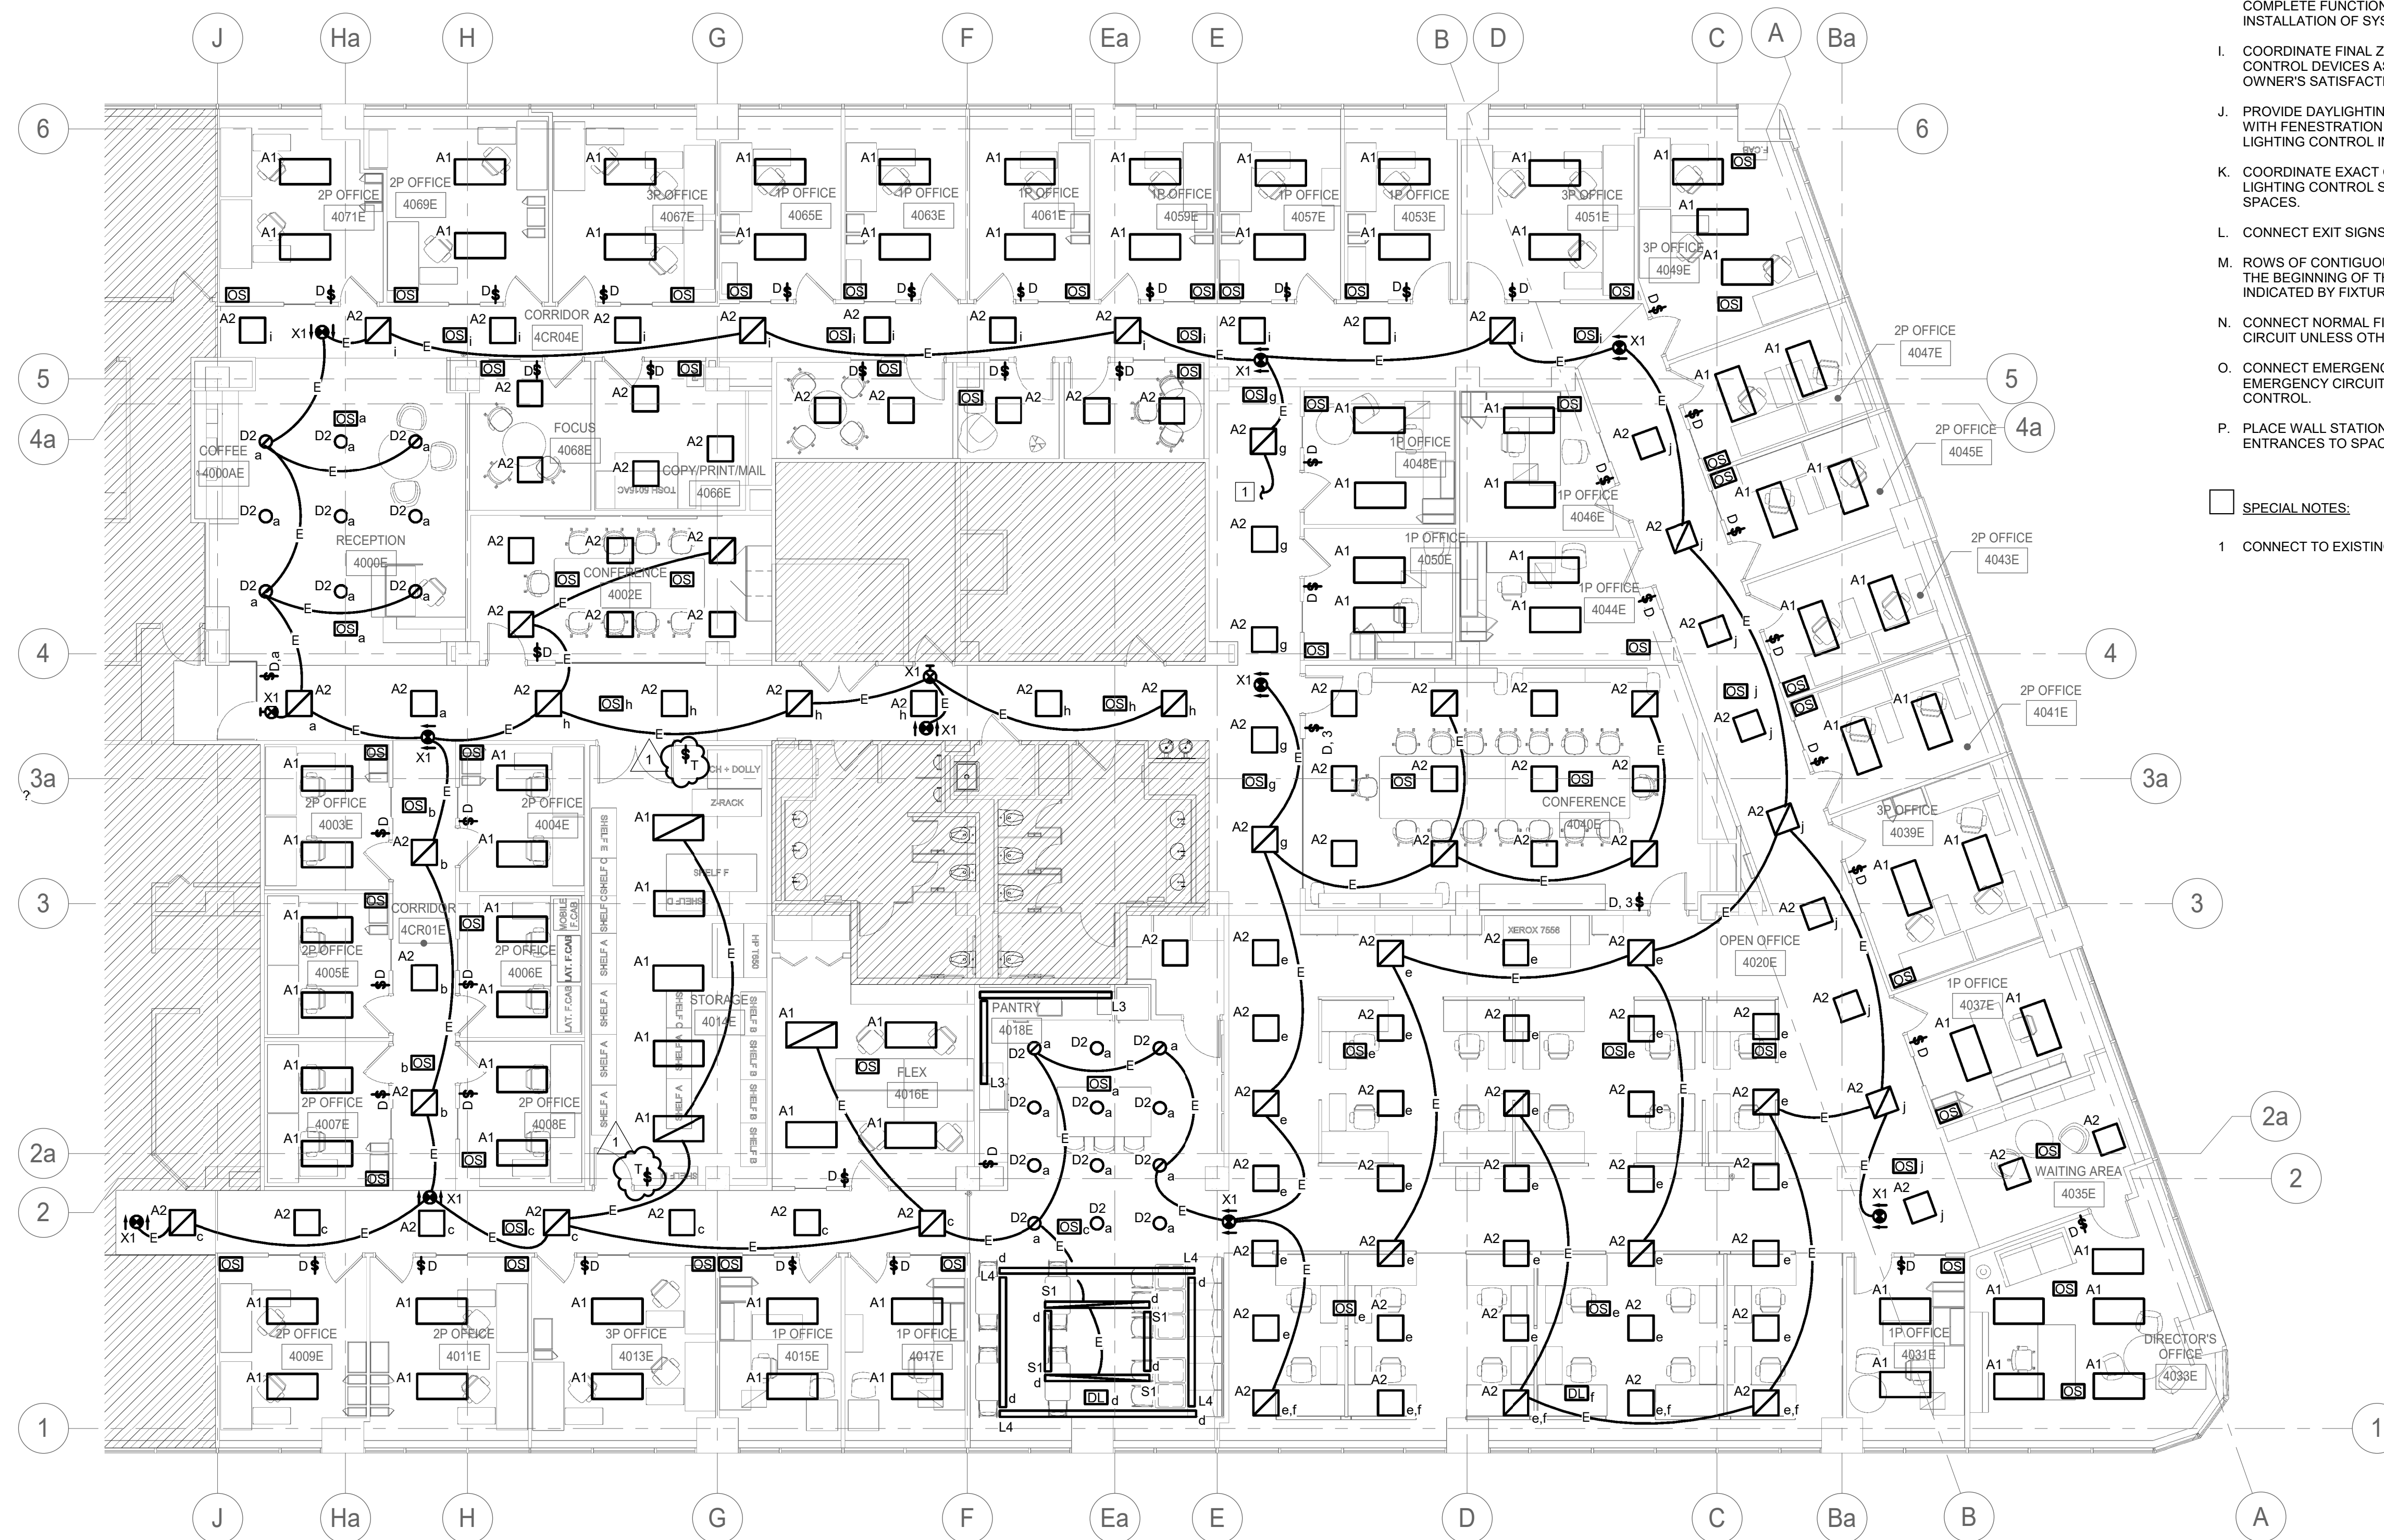

1 FLOOR PLAN - LEVEL 4 - ELECTRICAL LIGHTING  
E-101LP 1/8" = 1'-0"

DRAWING NOTES:

- REFER TO DRAWING E-001SH FOR SYMBOLS LEGEND, ABBREVIATIONS AND DRAWING CONVENTIONS.
- HEAVY LINE WEIGHT INDICATES NEW WORK AND LIGHT LINE WEIGHT INDICATES EXISTING EQUIPMENT TO REMAIN.
- EXISTING CONDITIONS SHOWN ARE BASED ON LIMITED FIELD SURVEY AND EXISTING DOCUMENTATION. VERIFY ALL EXISTING CONDITIONS WHETHER INDICATED OR NOT.
- CONNECT NEW LIGHTING FIXTURES TO NEAREST EXISTING LIGHTING FIXTURE CIRCUIT, UNLESS OTHERWISE NOTED. MAKE CONNECTIONS USING MC CABLE. CONTRACTOR IS RESPONSIBLE FOR TRACING EXISTING LIGHTING CIRCUITS TO BE USED UNDER NEW WORK. EXISTING LIGHTING CIRCUITS ARE ASSUMED TO ORIGINATE FR40M PANELS IN NORTH MECHANICAL ROOM.
- PROVIDE EMERGENCY LIGHTING BYPASS DEVICES IN EACH SPACE WITH EMERGENCY AND NORMAL LIGHTING PRESENT WITHIN THE SPACE. EMERGENCY LIGHTING FIXTURES SHALL BE CONTROLLED IN THE SAME MANNER AS NORMAL LIGHTING FIXTURES WITHIN THE SAME SPACE. REFER TO EMERGENCY LIGHTING BYPASS DEVICE DETAIL FOR TYPICAL WIRING OF DEVICE. PROVIDE ADDITIONAL CONNECTIONS REQUIRED FOR PROPER OPERATION OF BYPASS DEVICE.
- REFER TO LIGHTING FIXTURE SCHEDULE FOR LIGHTING FIXTURE TYPE INFORMATION AND REQUIREMENTS.
- REFER TO LIGHTING CONTROL INTENT SCHEDULE FOR LIGHTING CONTROL REQUIREMENTS IN EACH SPACE TYPE.
- LIGHTING CONTROLS SHOWN ARE DIAGRAMMATIC AND DO NOT INDICATE EVERY PIECE OF HARDWARE AND SOFTWARE REQUIRED TO MEET CONTROL INTENT. SUBMIT COMPLETE SHOP DRAWINGS INCLUDING WIRING DIAGRAMS AND BILL OF MATERIALS INCLUDING ALL HARDWARE AND SOFTWARE FOR COMPLETE FUNCTIONING SYSTEM THAT MEETS CONTROL INTENT PRIOR TO INSTALLATION OF SYSTEM.
- COORDINATE FINAL ZONING AND SCENES WITH OWNER. PROVIDE ADDITIONAL CONTROL DEVICES AS NEEDED. PROVIDE ZONING AND SCENES TO THE OWNER'S SATISFACTION.
- PROVIDE DAYLIGHTING ZONES PER ASHRAE 90.1, CHAPTER 9, IN ALL SPACES WITH FENESTRATION. REFER TO AUTOMATIC DAYLIGHT DIMMING NOTE IN THE LIGHTING CONTROL INTENT SCHEDULE NOTES.
- COORDINATE EXACT QUANTITY AND LOCATION OF OCCUPANCY SENSORS WITH LIGHTING CONTROL SYSTEM VENDOR TO PROVIDE PROPER DETECTION IN ALL SPACES.
- CONNECT EXIT SIGNS AHEAD OF SWITCHING AND DIMMING CONTROLS.
- ROWS OF CONTIGUOUS FIXTURES OF THE SAME TYPE ARE TAGGED ONLY AT THE BEGINNING OF THE ROW. PROVIDE SEPARATE FIXTURES IN ROWS AS INDICATED BY FIXTURE SYMBOLS.
- CONNECT NORMAL FIXTURES ON THE SAME ROW TO THE SAME NORMAL CIRCUIT UNLESS OTHERWISE NOTED OR REQUIRED FOR CONTROL.
- CONNECT EMERGENCY FIXTURES ON THE SAME ROW TO THE SAME EMERGENCY CIRCUIT UNLESS OTHERWISE NOTED OR REQUIRED FOR CONTROL.
- PLACE WALL STATIONS AND SWITCHES AS CLOSE AS POSSIBLE TO ENTRANCES TO SPACES.

SPECIAL NOTES:

- CONNECT TO EXISTING EMERGENCY LIGHTING BRANCH CIRCUIT



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PROJECT NORTH




KEY PLAN

0 4' 8' 16'  
1/8"=1'-0"

GRAPHIC SCALE(S)

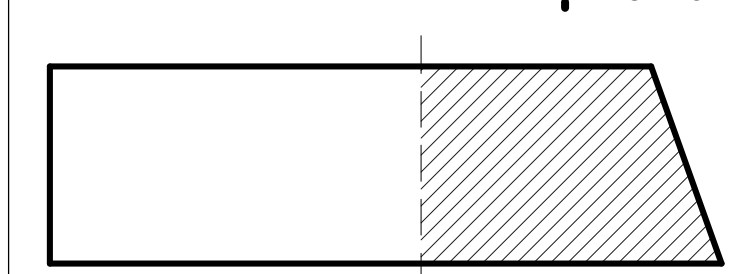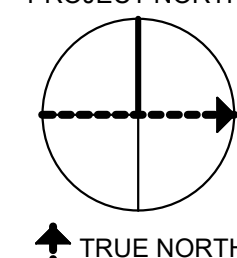DATE	SUBMISSION
04/18/25	FINAL CONSTRUCTION DOCS
REVISION #	DATE
1	08/26/25

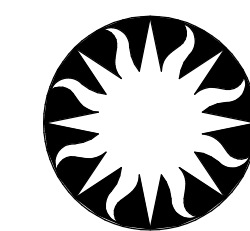

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BUILDING NAME	CAPITAL GALLERY ADMIN HQ, EAST
ADDRESS	600 MARYLAND AVE, SW
PROJECT TITLE	RENOVATE 4E NMAL OFFICE SUITE
SI PROJECT NUMBER	2466904
A/E PROJECT NUMBER	ASG 3000738.00
DRAWING TITLE	ELECTRICAL LIGHTING PLAN-PARTIAL LEVEL 4 - NORTH
WORKING STAFF	ARF SBP POC
SHEET NO.	E - 101LP
35 of 75	DISCIPLINE TYPE SEQUENCE DRAWING TYPE




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CG


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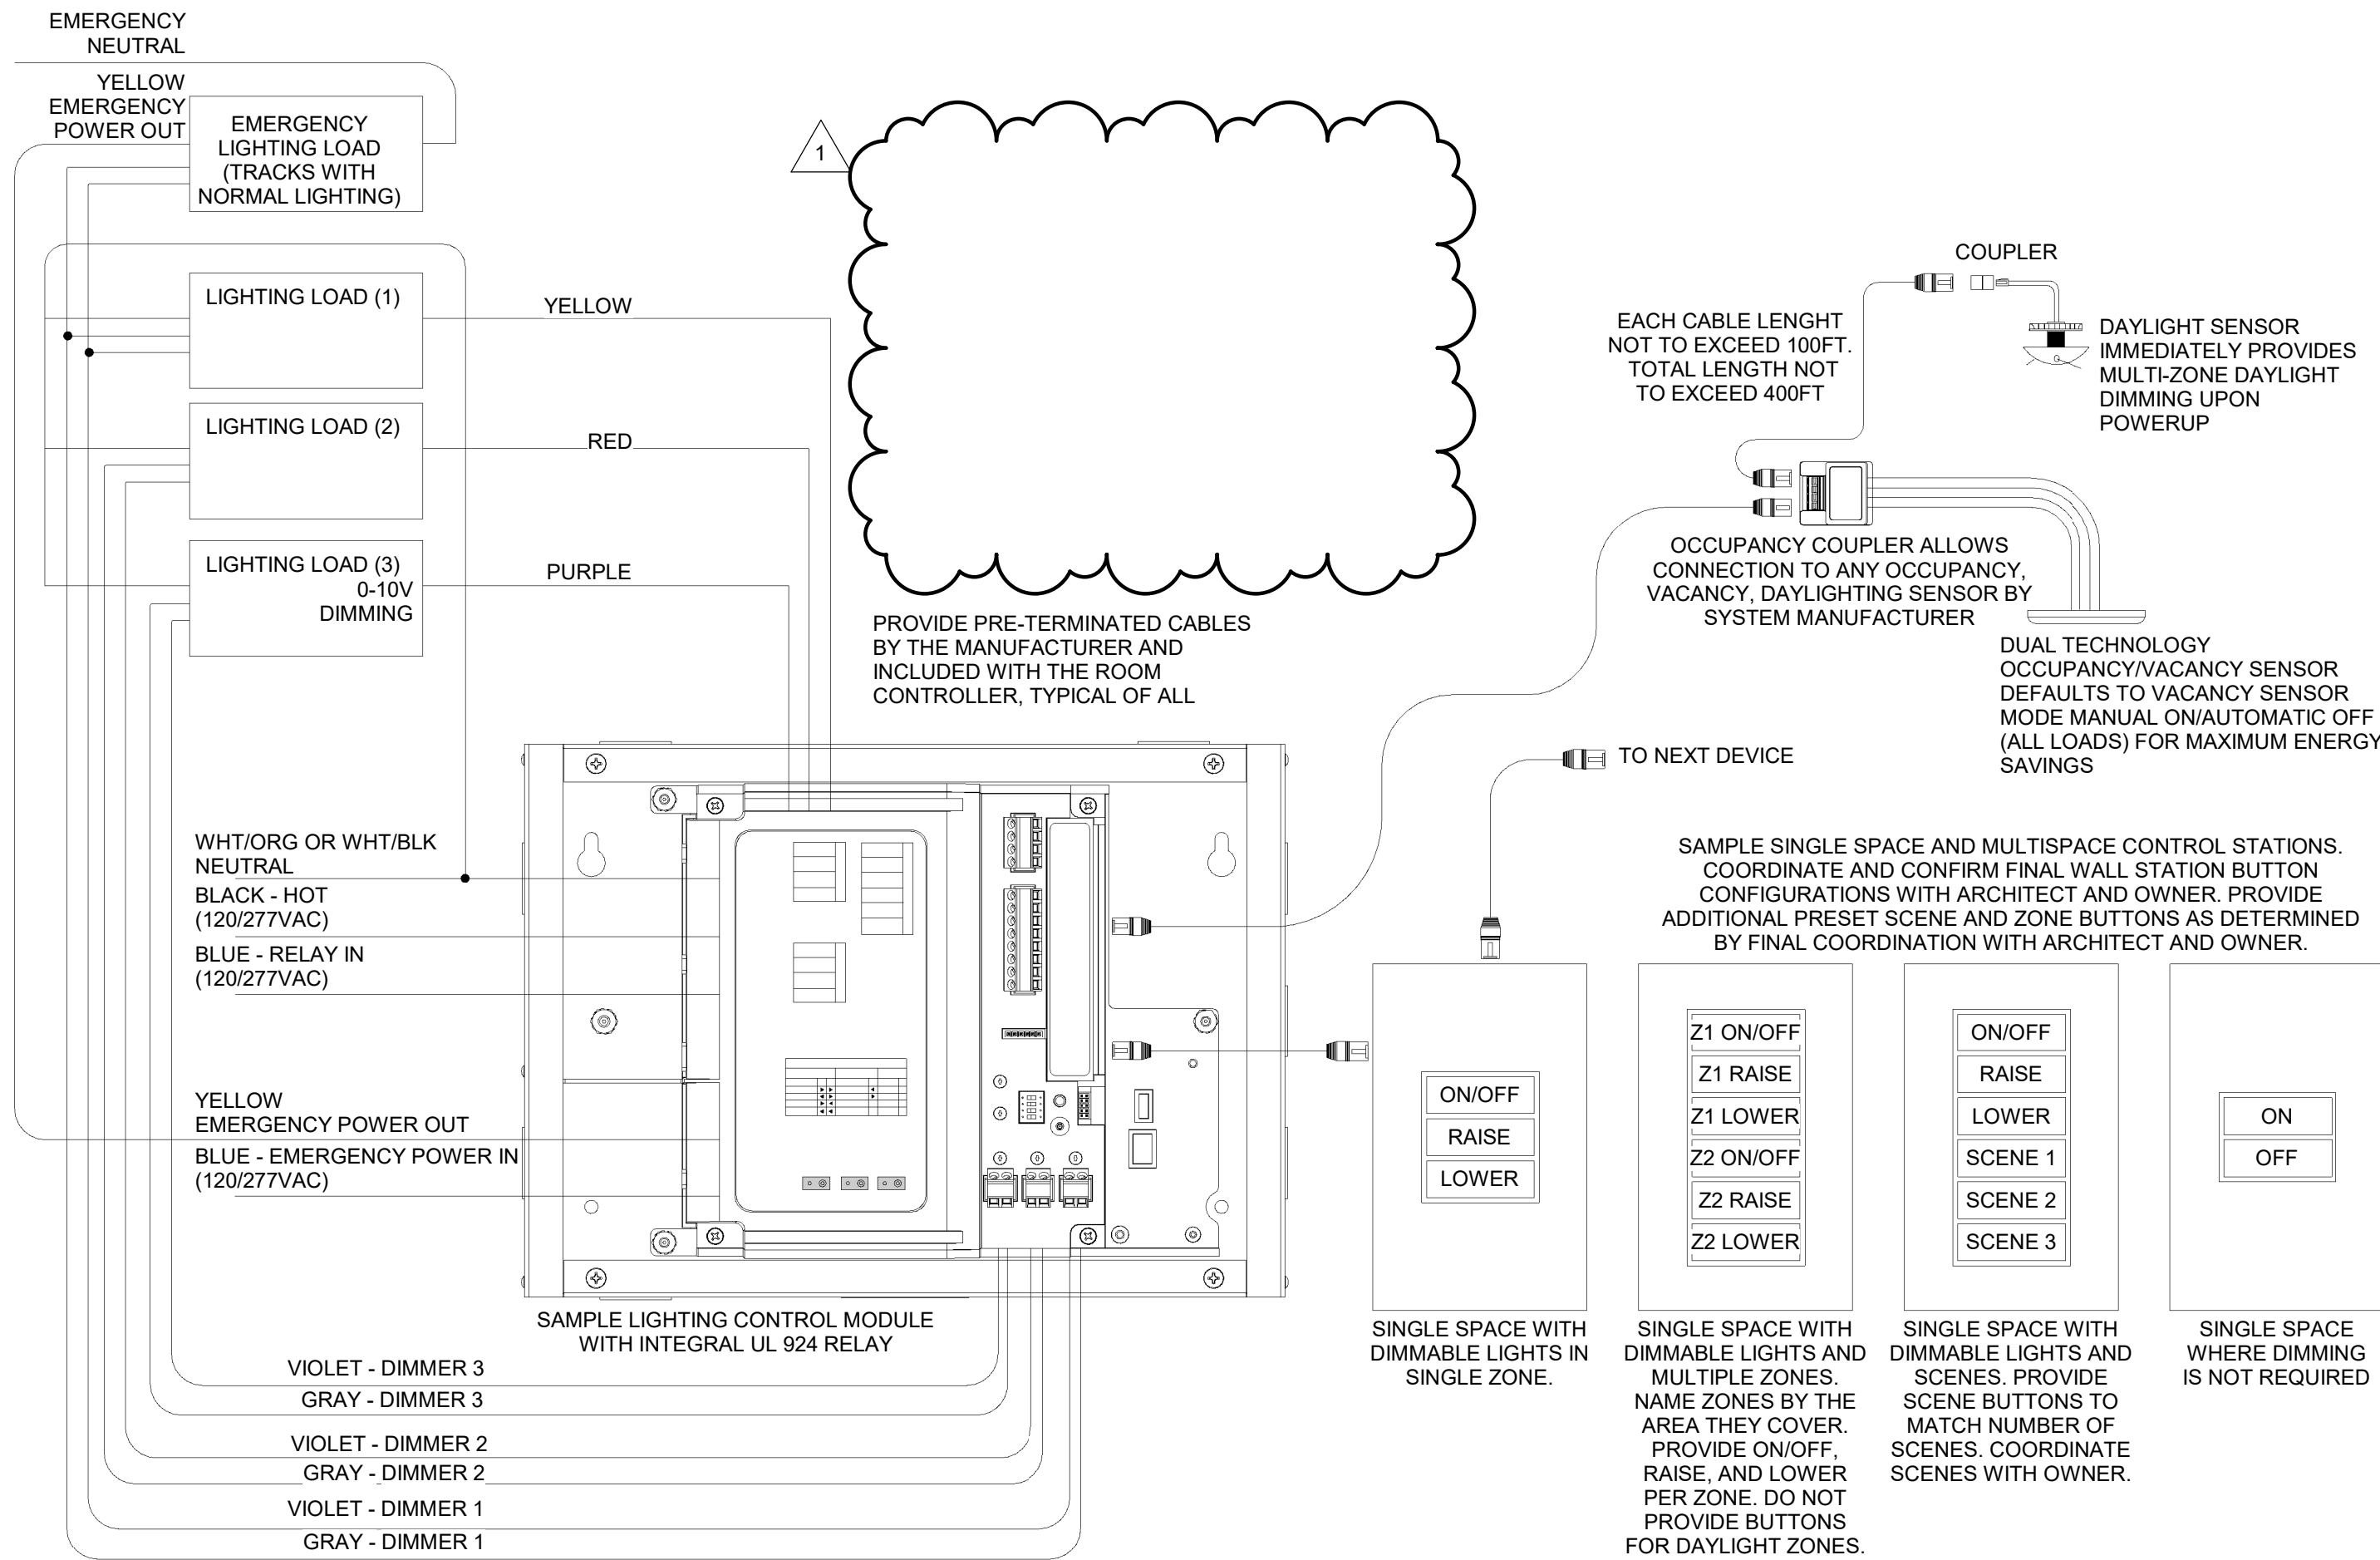
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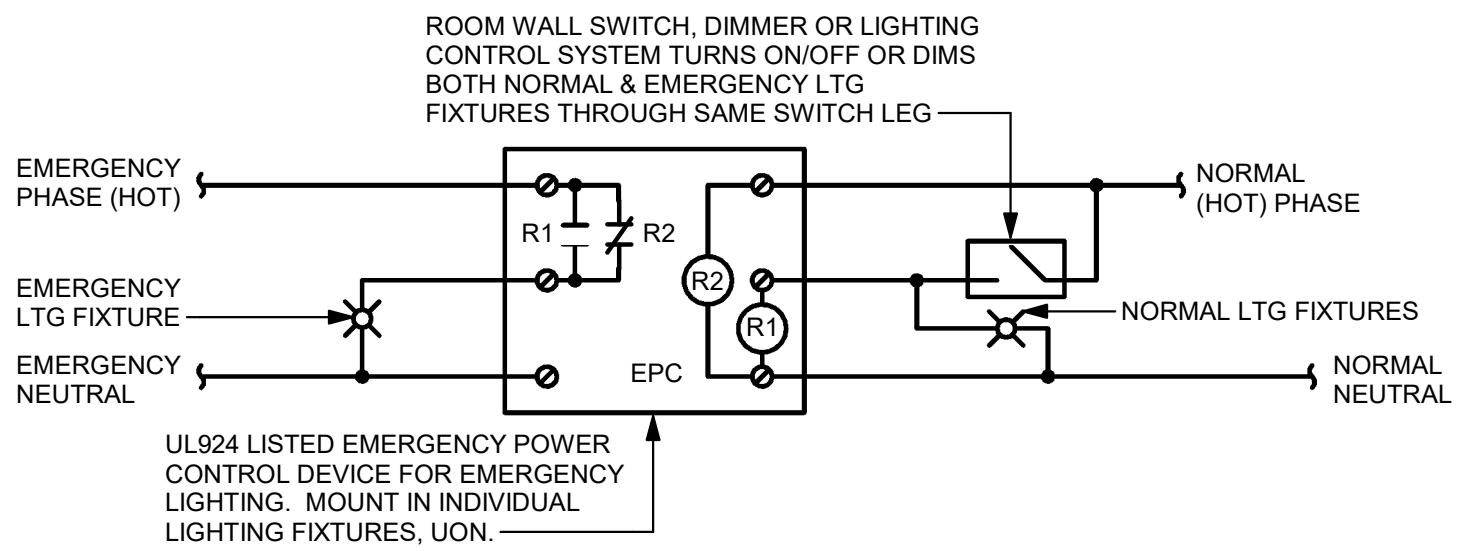
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E-501DT NOT TO SCALE



2 LIGHTING FIXTURE SUPPORT  
E-501DT NOT TO SCALE

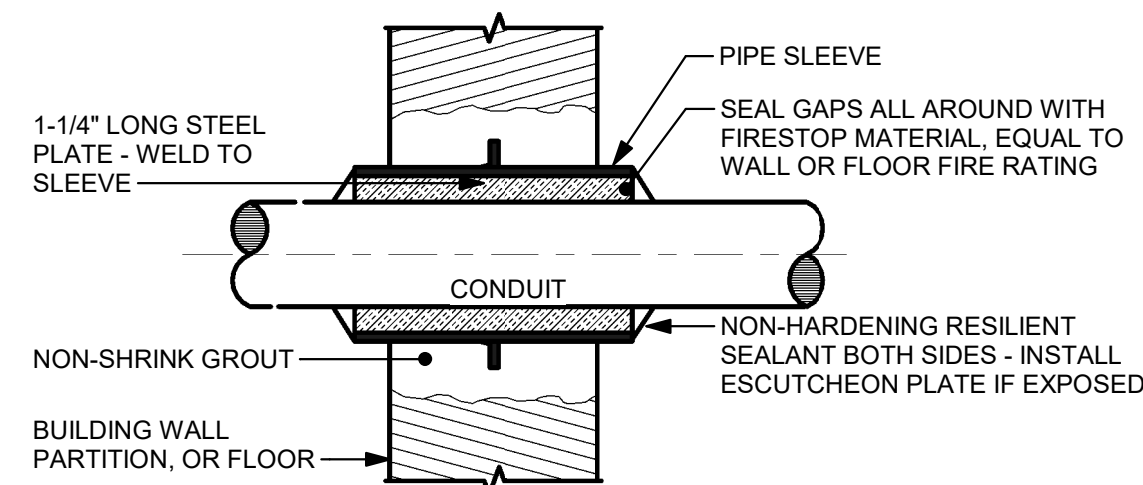


4 SCHEMATIC LIGHTING CONTROL SYSTEM DIAGRAM  
E-501DT 1/8" = 1'-0"

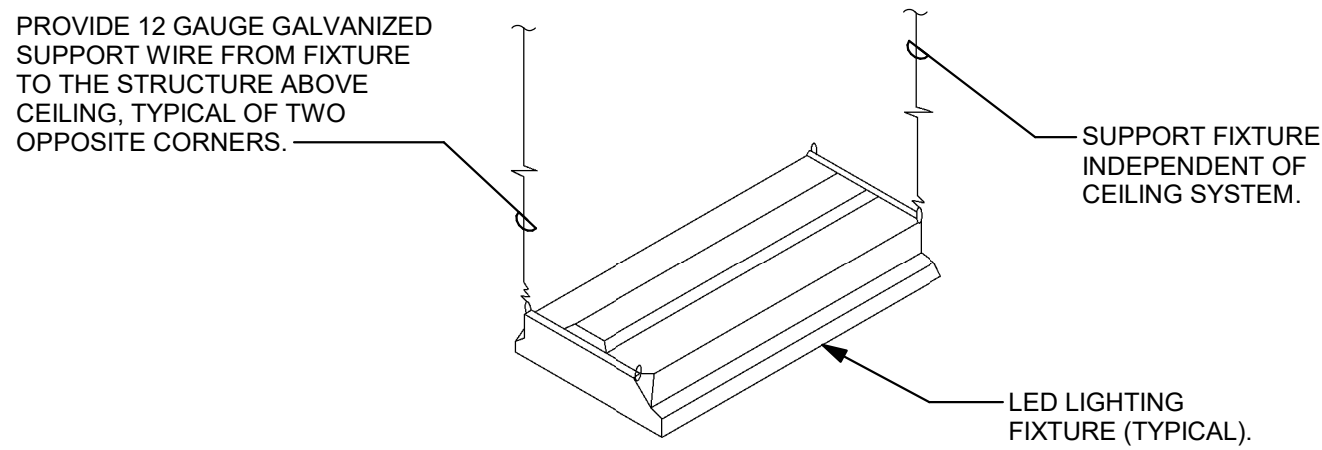

NOTES:  
1. DURING NORMAL POWER OUTAGE, EMERGENCY LIGHTING FIXTURES (FED FROM EMERGENCY GENERATOR DISTRIBUTION SYSTEM) WILL ILLUMINATE AUTOMATICALLY REGARDLESS OF ROOM SWITCH ON/OFF OR DIM POSITION.

3 EMERGENCY LIGHTING BYPASS DEVICE - BACK OF HOUSE  
E-501DT NOT TO SCALE

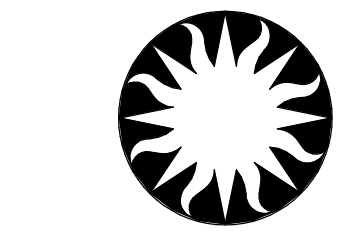

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PROJECT TITLE	RENOVATE 4E NMAL OFFICE SUITE
S/ PROJECT NUMBER	2466904
A/E PROJECT NUMBER	ASG 3000738.00
DRAWING TITLE	ELECTRICAL DETAILS
WORKING STAFF	ARF SBP POC
SHEET NO.	E - 501DT
37 of 75	DISCIPLINE TYPE SEQUENCE DRAWING TYPE

LIGHTING FIXTURE SCHEDULE						
FIXTURE TYPE	MOUNTING	MANUFACTURERS	CATALOG NUMBER	LAMPS	VOLTAGE	DESCRIPTION
A1	CEILING RECESSED	LITHONIA COOPER LIGHTING HUBBELL LIGHTING	2RTL4_-_40L_-_GZ10-LP835	LED (INCLUDED)	277	2'X4' LED RECESSED FIXTURE, COLD ROLLED STEEL HOUSING, ACRYLIC PRISMATIC REFLECTOR, WHITE POLYESTER POWDER PAINT FINISH, DRIVER 0-10V DIMMING TO 10%, 3500K CCT, 82 CRI, 4840 LUMENS, 39.4W.
A2	CEILING RECESSED	LITHONIA COOPER LIGHTING HUBBELL LIGHTING	2RTL2_-_40L_-_GZ10-LP835	LED (INCLUDED)	277	2'X2' LED RECESSED FIXTURE, COLD ROLLED STEEL HOUSING, ACRYLIC PRISMATIC REFLECTOR, WHITE POLYESTER POWDER PAINT FINISH, DRIVER 0-10V DIMMING TO 10%, 3500K CCT, 82 CRI, 4840 LUMENS, 41.4W.
D2	CEILING RECESSED	PRESCOLITE COOPER LIGHTING LITHONIA	LTR-4RD-H-SL-10L-DM01-L-TR-ARD-T-SL-35K-8-WD	LED (INCLUDED)	277	4" ROUND LED DOWNLIGHT, WIDE DISTRIBUTION, GALVANIZED STEEL HOUSING, WHITE MATTE DIFFUSE FINISH, DRIVER 0-10V DIMMING TO >1%, 3500K CCT, 80 CRI, 1062 LUMENS, 12W.
L3	CEILING RECESSED	LITECONTROL COOPER LIGHTING LITHONIA	4L-SS-D_-_04-ASYM-C1-35K-D030-D01-1C-UNV	LED (INCLUDED)	277	RECESSED LINEAR LED LIGHTING FIXTURE, EXTRUDED ALUMINUM HOUSING, MATTE WHITE FINISH, ASSYMETRIC DIFFUSE LENS, DRIVER 0-10V DIMMING TO 1%, PROVIDE MITERED CORNERS TO CREATE SEAMLESS RECTANGULAR SHAPE. LENGTHS AS INDICATED ON DRAWINGS. 3500K CCT, 90 CRI, 300 LUMENS PER FOOT, 2.5W PER FOOT.
L4	CEILING RECESSED	LITECONTROL COOPER LIGHTING LITHONIA	4L-SS-D_-_04-SOF-C1-35K-D030-D01-1C-UNV	LED (INCLUDED)	277	2" APERTURE RECESSED LINEAR LED LIGHTING FIXTURE, EXTRUDED ALUMINUM HOUSING, MATTE WHITE FINISH, SOFT DIFFUSE LENS, DRIVER 0-10V DIMMING TO 1%. PROVIDE MITERED CORNERS TO CREATE SEAMLESS RECTANGULAR SHAPE. LENGTHS AS INDICATED ON DRAWINGS. 3500K CCT, 90 CRI, 300 LUMENS PER FOOT, 2.5W PER FOOT.
S1	CEILING RECESSED	INTERLUX COLUMBIA LITHONIA	WG-20LDL-SM-GT9T-S-H-935-D010-OD-W-C4	LED (INCLUDED)	277	GRID CLIP RECESSED LINEAR LED LIGHTING FIXTURE, WHITE FINISH, SATIN OPAL DIFUSER, DRIVER 0-10V DIMMING TO 10%. LENGTHS AS INDICATED ON DRAWINGS. 3500K CCT, 90 CRI, 796 LUMENS PER FOOT, 10W PER FOOT.
X1	CEILING OR WALL	LITHONIA COOPER LIGHTING HUBBELL LIGHTING LIGHTALARMS	EDG_-_1-GMR	LED (INCLUDED)	277	EDGE LIT EXIT SIGN, GREEN LETTERS ON MIRRORRED BACKGROUND, EXTRUDED BRUSHED ALUMINUM FINISH, UL DAMP LOCATION LISTED. PROVIDE MOUNTING AND NUMBER OF FACES AND CHEVRONS AS INDICATED ON PLANS. AC VOLTAGE ONLY. WALL MOUNTED EXIT SIGNS ABOVE DOORS SHALL BE 6" ABOVE TOP OF DOOR FRAME, MEASURED FROM BOTTOM OF EXIT SIGN, UNLESS OTHERWISE NOTED. 4.5W

EQUIPMENT CIRCUIT SCHEDULE																		
DESIGNATION	LOAD			VOLTAGE	PH	LOCAL DISCONNECT			CONTROLLER					CIRCUIT			REMARKS	
	HP	KVA	AMPS			AMPS	DEVICE	NEMA / UL ENCLOSURE	DISCONNECT		TYPE	NEMA SIZE	AUXILIARIES	NEMA / UL ENCLOSURE	WIRE	GND		C"
									AMPS	DEVICE								
WSHP-1	1/3	1.3	4.7	277	1	-	BY DIV 23	-	-	-	BY DIV 23	-	-	-	2#12	#12	3/4	
WSHP-2	1/3	1.9	6.8	277	1	-	BY DIV 23	-	-	-	BY DIV 23	-	-	-	2#12	#12	3/4	

LIGHTING CONTROL INTENT SCHEDULE													
SPACE TYPE	MANUAL CONTROL	MANUAL ON	AUTOMATIC PARTIAL ON	AUTOMATIC FULL ON	SCHEDULED FULL ON	BILEVEL DIMMING	CONTINUOUS DIMMING	AUTOMATIC DAYLIGHT DIMMING	AUTOMATIC PARTIAL OFF	AUTOMATIC FULL OFF	SCHEDULED FULL OFF	REMARKS	
ELECTRICAL / MECHANICAL / TELECOM / SECURITY / UTILITY ROOM	X	X										ON / OFF TOGGLE SWITCH.	
INDIVIDUAL OFFICE / ENCLOSED MULTI-OCCUPANT OFFICE / MEETING / CONFERENCE / MULTIPURPOSE / CLASSROOM / LOUNGE / BREAK ROOM / LOCKER / STORAGE / TRASH RECYCLE / JANITOR	X	X					X	X		X		PROVIDE SEPARATE ZONE FOR GROUP OF LIGHTS ADJACENT TO PROJECTION WALLS.	
OPEN OFFICE	X	X					X	X		X	X	OCCUPANCY SENSORS SHALL MAINTAIN LIGHTS ON AND TURN LIGHTS OFF AFTER HOURS.	
LOBBY / CORRIDOR / VESTIBULE / STAIRWELL	X			X			X	X	X	X	X	LIGHTS SHALL BE ON AT 50% DURING OPERATING HOURS. OCCUPANCY SENSORS SHALL MAINTAIN LIGHTS ON AND TURN LIGHTS OFF AFTER HOURS. LOCATE WALL STATION IN SECURE SPACE ONLY ACCESSIBLE TO AUTHORIZED PERSONNEL.	

LIGHTING FIXTURE SCHEDULE NOTES:

- LISTED CATALOG NUMBER IS FOR FIRST NAMED MANUFACTURER. FIRST NAMED MANUFACTURERS AND LISTED FIXTURES CONSTITUTE THE BASIS OF DESIGN.
- LISTING OF ALTERNATE MANUFACTURER'S NAMES DOES NOT IMPLY ACCEPTANCE OF THEIR STANDARD PRODUCTS. PROVIDE BASIS OF DESIGN FIXTURES OR FIXTURES BY LISTED MANUFACTURERS THAT ARE EQUAL TO OR BETTER THAN THE BASIS OF DESIGN IN ALL ASPECTS.
- SUBSTITUTION OF FIXTURES PROVIDED BY MANUFACTURERS NOT LISTED IN THE SCHEDULE DUE TO VENDOR AGREEMENTS WILL BE REVIEWED UNLESS OTHERWISE NOTED. PROVIDE FIXTURES THAT ARE EQUAL TO OR BETTER THAN THE BASIS OF DESIGN IN ALL ASPECTS. FIXTURES NOT COMPLYING WITH THIS REQUIREMENT WILL BE REJECTED.
- LIGHTING FIXTURE SUBMITTALS SHALL INCLUDE, AS A MINIMUM:  
-FIXTURE TYPE, DIMENSIONS, & FINISH.  
-DRIVER DATA FOR EACH FIXTURE TYPE & FIXTURE VOLTAGE.
- VERIFY ALL LIGHTING FIXTURE VOLTAGES, CEILING TRIM, AND OTHER ACCESSORIES FOR COMPATIBILITY WITH CIRCUITS, CEILING TYPES AND OTHER CONDITIONS PRESENT WHERE LIGHTING FIXTURES WILL BE INSTALLED PRIOR TO PURCHASE AND INSTALLATION OF LIGHTING FIXTURES.
- COORDINATE LIGHTING CONTROL SYSTEM SHOP DRAWINGS WITH LIGHTING FIXTURE SHOP DRAWINGS. VERIFY COMPATIBILITY WITH LED DIMMING DRIVERS WITH LIGHTING CONTROL EQUIPMENT PRIOR TO PURCHASE AND INSTALLATION.
- MOUNTING HEIGHTS SHOWN ARE TO BOTTOM OF FIXTURES.
- PROVIDE ACCESSORIES AS NEEDED FOR PROPER INSTALLATION.
- REFER TO ARCHITECTURAL DRAWINGS FOR EXACT LOCATION OF FIXTURES.

EQUIPMENT CIRCUIT SCHEDULE NOTES:

- PROVIDE MOTOR CIRCUIT PROTECTORS AS REQUIRED BY THE EQUIPMENT MANUFACTURER.
- SIZE AND PROVIDE FUSES FOR FUSED SAFETY SWITCHES AS RECOMMENDED AND REQUIRED BY MANUFACTURER OF EQUIPMENT SERVED.

AUXILIARIES:

- 480-120V CONTROL POWER TRANSFORMER.
- RED "ON" INDICATING LIGHT.
- GREEN "OFF" INDICATING LIGHT.
- HAND-OFF-AUTOMATIC SELECTOR SWITCH.
- START-STOP PUSH BUTTON.
- POWER FACTOR CORRECTION CAPACITORS.

LIGHTING CONTROL INTENT SCHEDULE NOTES:

- MANUAL CONTROL: THE SPACE IS REQUIRED TO HAVE WALL STATION WITHIN IT UNLESS OTHERWISE NOTED.
- MANUAL ON: THE USER IS REQUIRED TO TURN THE LIGHTING FIXTURES ON. THE OCCUPANCY SENSORS IN THE SPACE SHALL NOT TURN THE LIGHTING FIXTURES ON AUTOMATICALLY.
- AUTOMATIC PARTIAL ON: THE OCCUPANCY SENSORS IN THE SPACE SHALL TURN THE LIGHTING FIXTURES TO 50% OUTPUT. THE USER MAY TURN THE LIGHTING FIXTURES TO FULL ON.
- AUTOMATIC FULL ON: THE OCCUPANCY SENSORS IN THE SPACE SHALL TURN THE LIGHTING FIXTURES TO 100% OUTPUT WHEN SOMEONE ENTERS THE SPACE.
- SCHEDULED FULL ON: THE LIGHTING FIXTURES IN THE SPACE SHALL TURN ON AS SCHEDULED BEFORE THE BUILDING OPENS TO THE PUBLIC. TIME SIGNAL SHALL COME FROM THE BAS.
- BILEVEL DIMMING: THE CONTROLS SHALL BE CAPABLE OF SETTING THE LIGHTING FIXTURES TO 0%, 50% OR 100% OUTPUT.
- CONTINUOUS DIMMING: THE CONTROLS SHALL BE CAPABLE OF DIMMING THE LIGHTING FIXTURES IN THE SPACE SMOOTHLY FROM THE LOWER RANGE ALLOWED BY THEIR DRIVERS TO 100% OUTPUT.
- AUTOMATIC DAYLIGHT DIMMING: APPLIES ONLY TO SPACES THAT RECEIVE DAYLIGHT. THE CONTROLS SHALL ADJUST THE OUTPUT OF THE LIGHTING FIXTURES WITHIN THE DAYLIGHT ZONE(S) TO ACCOUNT FOR VARIATIONS IN DAYLIGHT. PROVIDE DAYLIGHT ZONES AS DESCRIBED BELOW. THESE ZONES COMPLY WITH ASHRAE 90.1, CHAPTER 9.
  - DAYLIGHT ZONES NEXT TO FENESTRATION ON WALLS: PROVIDE TWO SEPARATE, PRIMARY AND SECONDARY, CONTROL ZONES PER FENESTRATION. COMBINE CONTROL OF ZONES THAT OVERLAP.
    - X = DISTANCE FROM FLOOR TO TOP OF FENESTRATION.
    - PRIMARY ZONE DEPTH = FROM FENESTRATION TO X INTO THE SPACE OR TO WALL IN FRONT OF FENESTRATION IF CLOSER THAN X.
    - SECONDARY ZONE DEPTH = FROM X TO 2X INTO THE SPACE OR TO WALL IN FRONT OF FENESTRATION IF CLOSER THAN 2X.
    - PRIMARY AND SECONDARY ZONE WIDTHS = FENESTRATION WIDTH PLUS 0.5X ON EACH SIDE OR TO WALLS ON SIDES OF FENESTRATION IF CLOSER THAN 0.5X.
  - DAYLIGHT ZONES UNDER SKYLIGHTS: ONE CONTROL ZONE PER SKYLIGHT. COMBINE CONTROL OF ZONES THAT OVERLAP.
    - Y = DISTANCE FROM FLOOR TO CEILING.
    - ZONE AREA = SKYLIGHT AREA PLUS 0.7Y ON ALL SIDES.
  - DAYLIGHT ZONES UNDER LIGHT MONITORS: ONE CONTROL ZONE PER LIGHT MONITOR. COMBINE CONTROL OF ZONES THAT OVERLAP.
    - Z = DISTANCE FROM FLOOR TO LIGHT MONITOR SILL.
    - ZONE DEPTH = FROM FENESTRATION TO Z INTO THE SPACE OR TO WALL IN FRONT OF FENESTRATION IF CLOSER THAN Z.
    - ZONE WIDTH = FENESTRATION WIDTH PLUS TWO FEET ON EACH SIDE OR TO WALLS ON SIDES OF FENESTRATION IF CLOSER THAN TWO FEET.
- AUTOMATIC PARTIAL OFF: THE OCCUPANCY SENSORS IN THE SPACE SHALL DIM THE LIGHTING FIXTURES DOWN TO 50% OUTPUT WITHIN 10 MINUTES AFTER ALL OCCUPANTS LEAVE THE SPACE.
- AUTOMATIC FULL OFF: THE OCCUPANCY SENSORS IN THE SPACE SHALL TURN THE LIGHTING FIXTURES OFF WITHIN 10 MINUTES AFTER ALL OCCUPANTS LEAVE THE SPACE.
- SCHEDULED FULL OFF: THE LIGHTING FIXTURES IN THE SPACE SHALL TURN OFF AS SCHEDULED AFTER THE BUILDING IS CLOSED TO THE PUBLIC. TIME SIGNAL SHALL COME FROM THE BAS.
- COORDINATE BUILDING SCHEDULE WITH OWNER.
- COORDINATE ALL FINAL FUNCTIONS WITH OWNER AND ARCHITECT.

CG


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S/ PROJECT NUMBER	2466904		
A/E PROJECT NUMBER	ASG 3000738.00		
DRAWING TITLE	ELECTRICAL SCHEDULES		
WORKING STAFF	ARF	SBP	POC
	DESIGNED BY	DRAWN BY	CHECKED BY
SHEET NO.	E - 601SH		
38 of 75	DISCIPLINE	TYPE	SEQUENCE

PANELBOARD: 4HA		BUS RATING: 100 A		MAIN: 100A MCB	
MIN AIC: 4HA		VOLTS: 480Y/277V		PHASES: 3	
ENCLOSURE: NEMA 1		MOUNTING: SURFACE		FED FROM: FIELD VERIFY	
LOCATION: NORTH MECH ROOM		NOTES: EXISTING		WIRES: 4	

CKT #	ITEM SERVED	CB P	CB TA	AØ (KVA)	BØ (KVA)	CØ (KVA)	CB TA	CB P	ITEM SERVED	CKT #	
1	BUILDING CORE LIGHTS	1	20	0.0	0.0		20	1	LS TECH/WATER HEATER	2	
3	HALL LIGHTS	1	20		0.0	0.0	20	1	LIGHTS IN SM. ROOM. A.O.	4	
5	LIGHTS AMERICAN OPTOMETRIC	1	20			0.0	0.0	20	1	LIGHTS AMERICAN OPTOMETRIC	6
7	NORTHWEST LIGHTS	1	20	0.0	0.0			20	1	LIGHTS AMERICAN OPTOMETRIC	8
9	LS TECHNOLOGIES	1	20		0.0	0.0		20	1	LIGHTS AMERICAN OPTOMETRIC	10
11	MUELLER OFFICE LIGHTS	1	20			0.0	0.0	20	1	EAST LIGHTS	12
13	SPARE	1	20	0.0	0.0			20	1	SOUTHWEST LIGHTS	14
15	440 LIGHTS	1	20		0.0	0.0		30	1	INSTA-HOT ARCHITECTURE TECH	16
17	SPARE	1	20			0.0	0.0	20	1	SPARE IN CEILING	18
TOTAL PER PHASE:				0.0	0.0	0.0					
TOTAL CONNECTED:				0.0 KVA	0 A						

PANELBOARD: 4LA				BUS RATING: 400 A				MAIN: 3P 200A CB					
MIN AIC: 22,000				VOLTS: 208Y/120V				PHASES: 3 WIRES: 4					
ENCLOSURE: NEMA 1				MOUNTING: SURFACE				FED FROM: FIELD VERIFY					
LOCATION: NORTH MECH ROOM				NOTES: EXISTING									
CKT #	ITEM SERVED			CB P	CB TA	AØ (KVA)	BØ (KVA)	CØ (KVA)	CB TA	CB P	ITEM SERVED	CKT #	
1	AV RECEPT - FOCUS ROOMS			1	20	0.4	0.0		20	1	JMA SOLUTIONS RECEPTACLE	2	
3	SPARE			1	20		0.0	0.7	20	1	RECEPT - COPY/PRINT/MAIL 4066E	4	
5	JMA SOLUTIONS RECEPTACLE			1	20			0.0	0.0	20	1	JMA SOLUTIONS RECEPTACLE	6
7	JMA SOLUTIONS RECEPTACLE			1	20	0.0	0.0		20	1	JMA SOLUTIONS RECEPTACLE	8	
9	JMA SOLUTIONS RECEPTACLE			1	20		0.0	0.0	20	1	JMA SOLUTIONS RECEPTACLE	10	
11	JMA SOLUTIONS RECEPTACLE			1	20			0.0	0.0	20	1	JMA SOLUTIONS RECEPTACLE/LS TECH	12
13	RECEPT - CONFERENCE 4002E			1	20	0.5	0.9		20	1	RECEPT - OPEN OFFICE 4020E	14	
15	JMA SOLUTIONS RECEPTACLE			1	20		0.0	0.7	20	1	RECEPT - OPEN OFFICE 4020E	16	
17	JMA SOLUTIONS RECEPTACLE			1	20			0.0	0.2	20	1	AV RECEPT - CONFERENCE 4040E	18
19	JMA SOLUTIONS RECEPTACLE			1	20	0.0	0.0		20	1	JMA SOLUTIONS RECEPTACLE	20	
21	JMA SOLUTIONS RECEPTACLE			1	20		0.0	0.0	20	1	LS TECHNOLOGIES	22	
23	RECEPT - CONFERENCE 4040E			1	20			0.4	0.2	20	1	AV RECEPT - DIRECTOR'S OFFICE 4033E	24
25						0.0	0.0					26	
27	4LA1			3	20		0.0	0.0	20	3	4LA4	28	
29								0.0	0.0			30	
31						0.0	0.0		20	1	JMA SOLUTIONS RECEPTACLE	32	
33	4LA2			3	20		0.0	0.7	20	1	RECEPT - DIRECTOR'S OFFICE 4033E	34	
35								0.0	0.0	20	1	JMA SOLUTIONS RECEPTACLE	36
37						0.0	0.0		20	1	JMA SOLUTIONS RECEPTACLE	38	
39	4LA3			3	20		0.0	0.0	20	1	JMA SOLUTIONS RECEPTACLE	40	
41								0.0	0.0	20	1	CONDEN. PUMP	42
TOTAL PER PHASE:						1.8	2.2	0.7					
TOTAL CONNECTED:						4.7 KVA		13 A					

PANELBOARD: 4LA1		BUS RATING: 225 A		MAIN: 3P 200A CB						
MIN AIC: 22,000		VOLTS: 208Y/120V		PHASES: 3 WIRES: 4						
ENCLOSURE: NEMA 1		MOUNTING: SURFACE		FED FROM: FIELD VERIFY						
LOCATION: NORTH MECH ROOM		NOTES: EXISTING								
CKT #	ITEM SERVED	CB P	CB TA	AØ (KVA)	BØ (KVA)	CØ (KVA)	CB TA	CB P	ITEM SERVED	CKT #
1	FURNITURE WHIP - RECEPTION 4000E	1	20	0.4	0.4			20	1 FURNITURE WHIP - OPEN OFFICE 4020E	2
3	FURNITURE WHIP - OPEN OFFICE 4020E	1	20		0.4	0.4		20	1 FURNITURE WHIP - OPEN OFFICE 4020E	4
5	FURNITURE WHIP - OPEN OFFICE 4020E	1	20			0.4	0.4	20	1 FURNITURE WHIP - OPEN OFFICE 4020E	6
7	PRINTER RECEPTACLE (SAAB)	1	20	0.0	0.0			20	1 JMA SOLUTIONS RECEPTACLE	8
9	GFCI PANTRY (SAAB)	1	20		0.0	0.4		20	1 FURNITURE POKETHRU - OPEN OFFICE 4020E	10
11	FURNITURE POKETHRU - OPEN OFFICE 4020E	1	20			0.4	0.4	20	1 FURNITURE POKETHRU - OPEN OFFICE 4020E	12
13	JMA SOLUTIONS RECEPTACLE	1	20	0.0	0.4			20	1 POKETHRU - DIRECTOR'S OFFICE	14
15	JMA SOLUTIONS RECEPTACLE	1	20		0.0	0.0		20	1 JMA SOLUTIONS RECEPTACLE	16
17	SPARE	1	20			0.0	0.4	20	1 POKETHRU - CONFERENCE 4040E	18
19	SPARE	1	20	0.0	0.0			20	1 LS TECHNOLOGIES	20
21	GFCI PANTRY (SAAB)	1	20		0.0	0.0		20	1 JMA SOLUTIONS RECEPTACLE	22
23	FURNITURE POKETHRU - OPEN OFFICE 4020E	1	20			0.4	0.4	20	1 POKETHRU - CONFERENCE 4002E	24
25	RECEPT - FLEX 4016E	1	20	0.2	0.9			20	1 RECEPT - FLEX 4016E	26
27	POKETHRU - CONFERENCE 4040E	1	20		0.4	0.4		20	1 POKETHRU - CONFERENCE 4040E	28
29	REFRIGERATOR (SAAB)	1	20			0.0	0.4	20	1 POKETHRU - CONFERENCE 4002E	30
31	RECEPTACLE (SAAB)	1	20	0.0	0.0			20	2 SPARE	32
33	RECEPTACLE (SAAB)	1	20		0.0	0.0		20		34
35	LS TECHNOLOGIES	1	20			0.0	0.0	20	1 JMA SOLUTIONS RECEPTACLE	36
37	SPARE	2	20	0.0	0.9			20	1 RECEPT - CONFERENCE 4040E	38
39	SPARE				0.0	0.9		20	1 RECEPT - PANTRY 4018E	40
41	GARBAGE DISPOSAL - PANTRY 4018E	1	20			1.7	0.2	20	1 REFRIGERATOR - PANTRY 4018E	42
TOTAL PER PHASE:				3.1	2.7	4.7				
TOTAL CONNECTED:				10.5 KVA		29 A				

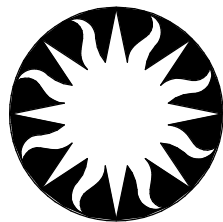PANELBOARD: 4EM		BUS RATING: 225 A		MAIN: 100 A							
MIN AIC: 4EM		VOLTS: 480Y/277V		PHASES: 3							
ENCLOSURE: NEMA 1		MOUNTING: SURFACE		FED FROM: FIELD VERIFY							
LOCATION: NORTH MECH ROOM		NOTES: EXISTING		WIRES: 4							
CKT #	ITEM SERVED	CB P	CB TA	AØ (KVA)	BØ (KVA)	CØ (KVA)	CB TA	CB P	ITEM SERVED	CKT #	
1	EXISTING LOAD	1	20	0.0	0.0			20	1	EXISTING LOAD	2
3	EXISTING LOAD	1	20		0.0	0.0		20	1	EXISTING LOAD	4
5	EXISTING LOAD	1	20			0.0	0.0	20	1	EXISTING LOAD	6
7	EXISTING LOAD	1	20	0.0	0.0			20	1	EXISTING LOAD	8
9	EXISTING LOAD	1	20		0.0	0.0		20	1	EXISTING LOAD	10
11	SPACE WITH PROVISIONS	1	--			--	--	1	SPACE WITH PROVISIONS	12	
13	SPACE WITH PROVISIONS	1	--	--	--			--	1	SPACE WITH PROVISIONS	14
15	SPACE WITH PROVISIONS	1	--		--	--	--	--	1	SPACE WITH PROVISIONS	16
17	SPACE WITH PROVISIONS	1	--			--	--	--	1	SPACE WITH PROVISIONS	18
19	SPACE WITH PROVISIONS	1	--	--	--			--	1	SPACE WITH PROVISIONS	20
21	SPACE WITH PROVISIONS	1	--		--	--	--	--	1	SPACE WITH PROVISIONS	22
23	SPACE WITH PROVISIONS	1	--			--	--	--	1	SPACE WITH PROVISIONS	24
25	SPACE WITH PROVISIONS	1	--	--	--			--	1	SPACE WITH PROVISIONS	26
27	SPACE WITH PROVISIONS	1	--		--	--	--	--	1	SPACE WITH PROVISIONS	28
29	SPACE WITH PROVISIONS	1	--			--	--	--	1	SPACE WITH PROVISIONS	30
TOTAL PER PHASE:				0.0	0.0	0.0					
TOTAL CONNECTED:				0.0 KVA		0 A					

PANELBOARD: 4LA5		BUS RATING: 225 A				MAIN: 150 A MCB					
MIN AIC: FIELD VERIFY		VOLTS: 208Y/120V				PHASES: 3					
ENCLOSURE: NEMA 1		MOUNTING: SURFACE				FED FROM: PANEL 4H					
LOCATION: NORTH MECH ROOM		NOTES: EXISTING				WIRES: 4					
CKT #	ITEM SERVED	CB P	CB TA	AØ (KVA)	BØ (KVA)	CØ (KVA)	CB TA	CB P	ITEM SERVED	CKT #	
1	ROOF TOP RECEPTACLE	1	20	0.0	0.0					2	
3	CONF RM 402 RECEPTACLE	1	20				80	3	PANEL "4LA6"	4	
5	REFRIGERATOR - REL	1	20		0.0	0.0				6	
7	GARBAGE DISPOSAL - REL	1	20	0.0	0.2		20	1	DISHWASHER - REL	8	
9	CONF RM 402 FLR POWER	1	20		0.0	0.2		20	1	NEW GFCI RECP - REL	10
11	MICROWAVE - REL	1	20			0.2	0.0	20	1	CONF RM 403 FLR POWER	12
13	RECEPTACLES	1	20	0.0	0.0			20	1	DEDIC RECEPTACLE RECEP 401	14
15	LAN RM RECP - REL	1	20		0.7	0.0		20	1	CONF RM 402 FLR POWER	16
17	RECEPTION AREA RECP - REL	1	20			0.5	0.0	20	1	CONF RM 403 RECEPTACLE	18
19				0.0	0.0			20	1	EXHAUST FAN LAN RM - REL	20
21	EMON - DMON	3	20		0.0	0.0		20	1	CONF RM 402 RECEPTACLE	22
23						0.0	0.0	20	1	CONF RM 403 RECEPTACLE	24
25	RECEPTACLES	1	20	0.0	0.7			20	1	RECEPT - STORAGE 4014E	26
27	RECEPTACLES	1	20		0.0	0.0		20	1	OFFICE 402 FLR POWER	28
29	PLOTTER - STORAGE 4014E	1	20			0.2	0.0	20	1	CONF RM 403 RECEPTACLE	30
31				0.0	0.0			20	1	EXHAUST FAN	32
33	LS TECHNOLOGIES SUB PANEL	3	60		0.0	0.0		20	1	PROJE & SCREEN CONF RM 402	34
35						0.0	0.0	20	1	CONF RM 403 RECEPTACLE	36
37	RECEPT - TELECOM 400T-N	1	20	0.2	0.1			20	2	NEMA RECEPT - TELECOM 400T-N	38
39	RECEPT - TELECOM 400T-N	1	20		0.2	0.1		20			40
41	SPARE	1	20			0.0	0.0	20	1	CONF RM 403 FLR POWER	42
TOTAL PER PHASE:				1.2	1.2	1.1					
TOTAL CONNECTED:				3.4 KVA		9 A					

DRAWING NOTES:

- A. INFORMATION IN EXISTING SCHEDULES HAS BEEN OBTAINED FROM GENERAL FIELD OBSERVATIONS. DETERMINE EXACT CIRCUIT CONDITIONS FOR EACH EXISTING PANELBOARD, MOTOR CONTROL CENTER, SWITCHBOARD, AND SWITCHGEAR IN FIELD. IF CONDITIONS ARISE THAT PRECLUDE WORK INDICATED, NOTIFY ENGINEER IMMEDIATELY AND WAIT FOR DIRECTION.
- B. FOR EXISTING SCHEDULES, CIRCUITS WITH DESIGNATIONS IN REGULAR TEXT ARE EXISTING TO REMAIN. NEW CIRCUITS ARE SHOWN IN BOLD TEXT. PROVIDE NEW CIRCUIT BREAKERS WHERE BREAKER AMPERAGE IS IN BOLD TEXT. DESCRIPTIONS OF CIRCUITS THAT HAVE BECOME SPARES AFTER DEMOLITION ARE SHOWN IN BOLD TEXT.
- C. WHERE NEW CIRCUIT BREAKERS ARE INDICATED IN EXISTING SCHEDULES, MATCH MANUFACTURER AND AIC RATING OF EXISTING CIRCUIT BREAKERS IN SAME DISTRIBUTION EQUIPMENT.
- D. PROVIDE UPDATED TYPED DIRECTORIES FOR ALL EXISTING AND RELOCATED PANELBOARDS INDICATING NEW AND EXISTING LOADS AFTER COMPLETION OF WORK. HANDWRITTEN DIRECTORIES ARE NOT ACCEPTABLE.

SPECIAL NOTES:

- 1 PROVIDE GFCI BREAKER.
- 2 RECONNECT CIRCUIT FROM DEMOLISHED 4LA5B PANEL.

CG


Renovate 4E NMAL  
Office Suite

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CONSTRUCTION

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GRAPHIC SCALE(S)

DATE	SUBMISSION
04/18/25	FINAL CONSTRUCTION DOCS
REVISION # DATE	REVISION DESCRIPTION
1 08/26/25	ADDENDUM #1

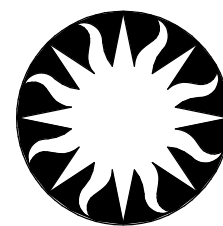

Smithsonian  
Institution

Smithsonian Institution  
600 Maryland Avenue S.W. Suite 5001  
Washington, DC 20024-2520

BUILDING NAME	CAPITAL GALLERY ADMIN HQ, EAST
ADDRESS	600 MARYLAND AVE, SW
PROJECT TITLE	RENOVATE 4E NMAL OFFICE SUITE
SI PROJECT NUMBER	2466904
A/E PROJECT NUMBER	ASG 3000738.00
DRAWING TITLE	PANELBOARD SCHEDULES
WORKING STAFF	ARF SBP POC
SHEET NO.	E - 602SH
42 of 75	DISCIPLINE TYPE SEQUENCE DRAWING TYPE

PANELBOARD: 4H		BUS RATING: 225 A		MAIN: 200 A						
MIN AIC: FIELD VERIFY		VOLTS: 480Y/277V		PHASES: 3						
ENCLOSURE: NEMA 1		MOUNTING: SURFACE		WIRES: 4						
LOCATION: NORTH MECH ROOM		NOTES: EXISTING		FED FROM: FIELD VERIFY						
CKT #	ITEM SERVED	CB P	CB TA	AØ (KVA)	BØ (KVA)	CØ (KVA)	CB TA	CB P	ITEM SERVED	CKT #
1	SPARE	1	20	0.0	0.0			15	1	2
3	AC4-2	1	15		0.0	0.0				4
5	ROOF MOUNTED DRYCOOLER AND PUMPS (DC-1 AND DP-1)	3	20	0.0	0.0		0.0	0.0	20	3
7										6
9					0.0	0.0				8
11	HHW-1	1	25				0.0	0.0	20	3
13	SPARE	1	20	0.0	0.0					10
15	SPACE WITH PROVISIONS	1	--		--	--		--	1	12
17	SPACE WITH PROVISIONS	1	--			--	--	--	1	14
19	SPACE WITH PROVISIONS	1	--	--	--			--	1	16
21	SPACE WITH PROVISIONS	1	--		--	--		--	1	18
23	SPACE WITH PROVISIONS	1	--		--	--	--	--	1	20
25	SPACE WITH PROVISIONS	1	--	--	--			--	1	22
27	SPACE WITH PROVISIONS	1	--		--	--		--	1	24
29	SPACE WITH PROVISIONS	1	--	--	--			--	1	26
31	SPACE WITH PROVISIONS	1	--		--	--		--	1	28
33	SPACE WITH PROVISIONS	1	--		--	--	--	--	1	30
35	SPACE WITH PROVISIONS	1	--		--	--		--	1	32
37		1	--	--	--			--	1	34
39	PANEL "4LA5" AND "4LA6" - 45 KVA TRANSFORMER	3	20	1.2	--			--	1	36
41					1.2	--		--	1	38
TOTAL PER PHASE:				1.2		1.2		1.1		40
TOTAL CONNECTED:				3.4 KVA				4 A		42

PANELBOARD: 4PA		BUS RATING: 225 A		MAIN: 200A MCB	
MIN AIC: FIELD VERIFY		VOLTS: 480Y/277V		PHASES: 3	
ENCLOSURE: NEMA 1		MOUNTING: SURFACE		WIRES: 4	
LOCATION: NORTH MECH ROOM		NOTES: EXISTING		FED FROM: FIELD VERIFY	

CKT #	ITEM SERVED	CB P	CB TA	AØ (KVA)	BØ (KVA)	CØ (KVA)	CB TA	CB P	ITEM SERVED	CKT #			
1	WESTWALL HEAT PUMPS	3	30	0.0	0.0					2			
3					0.0	0.0			30	3	NORTHEAST WALL HEAT PUMPS	4	
5								0.0	0.0			6	
7	NORTHWALL HEAT PUMPS	3	30	0.0	0.0					8			
9						0.0	0.0			30	3	NORTHEAST WALL HEAT PUMPS	10
11								0.0	0.0			12	
13	EAST WALL HEAT PUMPS	3	30	0.0	0.0					14			
15						0.0	0.0			25	3	SPARE	16
17								0.0	0.0			18	
19	WSHP-1	1	20	1.3	1.9				20	1	WSHP-2	20	
21	WSHP-1 CONDENSATE PUMP	1	20		0.4	0.4			20	1	WSHP-2 CONDENSATE PUMP	22	
23	SPARE	1	20				0.0	0.0	20	1	SPARE	24	
25	SPACE WITH PROVISIONS	1	--	--	--			--	1	SPACE WITH PROVISIONS	26		
27	SPACE WITH PROVISIONS	1	--		--	--		--	1	SPACE WITH PROVISIONS	28		

TOTAL PER PHASE:		3.2	0.7	0.0
TOTAL CONNECTED:		3.9 KVA	5 A	

PANELBOARD: 4LA5B		BUS RATING: 225 A				MAIN: 60 A					
MIN AIC: FIELD VERIFY		VOLTS: 208Y/120V				PHASES: 3					
ENCLOSURE: NEMA 1		MOUNTING: SURFACE				WIRES: 4					
LOCATION: RECEPTION 4000E		NOTES: EXISTING TO BE DEMOLISHED				FED FROM: FIELD VERIFY					
CKT #	ITEM SERVED	CB P	CB TA	AØ (KVA)	BØ (KVA)	CØ (KVA)	CB TA	CB P	ITEM SERVED	CKT #	
1	NEW GFCI RECP	1	20	0.0	0.0		20	1	RECEPTION AREA RECP	2	
3	DISHWASHER	1	20		0.0	0.0	20	1	LAN RM RECP	4	
5	GARBAGE DISPOSAL	1	20				20	1	EXHAUST FAN LAN RM	6	
7	MICROWAVE RECP	1	20	0.0	0.0		20	1	REFRIGERATOR	8	
9	SPARE	1	20		0.0	0.0	20	1	SPARE	10	
11	SPARE	1	20			0.0	0.0	20	1	SPARE	12
13	SPARE	1	20	0.0	0.0		20	1	SPARE	14	
15	SPACE WITH PROVISIONS	1	--	--	--	--	--	1	SPACE WITH PROVISIONS	16	
17	SPACE WITH PROVISIONS	1	--	--	--	--	--	1	SPACE WITH PROVISIONS	18	
19	SPACE WITH PROVISIONS	1	--	--	--	--	--	1	SPACE WITH PROVISIONS	20	
21	SPACE WITH PROVISIONS	1	--	--	--	--	--	1	SPACE WITH PROVISIONS	22	
23	SPACE WITH PROVISIONS	1	--	--	--	--	--	1	SPACE WITH PROVISIONS	24	
25	SPACE WITH PROVISIONS	1	--	--	--	--	--	1	SPACE WITH PROVISIONS	26	
27	SPACE WITH PROVISIONS	1	--	--	--	--	--	1	SPACE WITH PROVISIONS	28	
29	SPACE WITH PROVISIONS	1	--	--	--	--	--	1	SPACE WITH PROVISIONS	30	
TOTAL PER PHASE:				0.0	0.0	0.0					
TOTAL CONNECTED:				0.0 KVA		0 A					

DRAWING NOTES:

- A. INFORMATION IN EXISTING SCHEDULES HAS BEEN OBTAINED FROM GENERAL FIELD OBSERVATIONS. DETERMINE EXACT CIRCUIT CONDITIONS FOR EACH EXISTING PANELBOARD, MOTOR CONTROL CENTER, SWITCHBOARD, AND SWITCHGEAR IN FIELD. IF CONDITIONS ARISE THAT PRECLUDE WORK INDICATED, NOTIFY ENGINEER IMMEDIATELY AND WAIT FOR DIRECTION.
- B. FOR EXISTING SCHEDULES, CIRCUITS WITH DESIGNATIONS IN REGULAR TEXT ARE EXISTING TO REMAIN. NEW CIRCUITS ARE SHOWN IN BOLD TEXT. PROVIDE NEW CIRCUIT BREAKERS WHERE BREAKER AMPERAGE IS IN BOLD TEXT. DESCRIPTIONS OF CIRCUITS THAT HAVE BECOME SPARES AFTER DEMOLITION ARE SHOWN IN BOLD TEXT.
- C. WHERE NEW CIRCUIT BREAKERS ARE INDICATED IN EXISTING SCHEDULES, MATCH MANUFACTURER AND AIC RATING OF EXISTING CIRCUIT BREAKERS IN SAME DISTRIBUTION EQUIPMENT.
- D. PROVIDE UPDATED TYPED DIRECTORIES FOR ALL EXISTING AND RELOCATED PANELBOARDS INDICATING NEW AND EXISTING LOADS AFTER COMPLETION OF WORK. HANDWRITTEN DIRECTORIES ARE NOT ACCEPTABLE.

SPECIAL NOTES:

- 1 EXISTING PANEL TO BE DEMOLISHED. RECONNECT CIRCUITS TO PANEL 4LA5 AS SHOWN.

CG


Renovate 4E NMAL  
Office Suite

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DATE	SUBMISSION
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REVISION # DATE	REVISION DESCRIPTION
1 08/26/25	ADDENDUM #1



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Institution

Smithsonian Institution  
600 Maryland Avenue S.W. Suite 5001  
Washington, DC 20024-2520

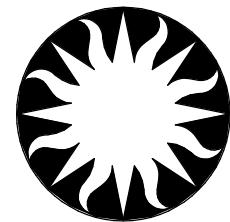BUILDING NAME	CAPITAL GALLERY ADMIN HQ, EAST		
ADDRESS	600 MARYLAND AVE, SW		
PROJECT TITLE	RENOVATE 4E NMAL OFFICE SUITE		
SI PROJECT NUMBER	2466904		
A/E PROJECT NUMBER	ASG 3000738.00		
DRAWING TITLE	PANELBOARD SCHEDULES		
WORKING STAFF	ARF	SBP	POC
	DESIGNED BY	DRAWN BY	CHECKED BY
SHEET NO.	E - 603 SH		
43 of 75	DISCIPLINE	TYPE	SEQUENCE



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GRAPHIC SCALE(S)

DATE \_\_\_\_\_

04/18/25

SUBMISSION

FINAL CONSTRUCTION DOCS

DECISION &amp; DATE

1 08/26/2

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REVISION 5

ADDENDUM #1

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Smithsonian Institution  
600 Maryland Avenue S.W. Suite 5001  
Washington, DC 20024-2520

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BUILDING

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CAPITAL GALLERY ADMIN HQ, EAST

600 MARYLAND AVE, SW

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SI PROJ

4/5 PR

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RENOVATE 4E NMAL OFFICE  
SUITE

2466904

ASG 3000738.00

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## ELECTRICAL SPECIFICATIONS

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DESIGNED BY	DRAWN BY	CHECKED
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